

# Generator and Electrical Equipment Replacement

## CLARKSBURG ELEMENTARY SCHOOL

13530 REDGRAVE PLACE, CLARKSBURG, MD 20871


### Montgomery County Public Schools

MECHANICAL AND ELECTRICAL ENGINEERS


JAMES POSEY ASSOCIATES, INC.  
11155 RED RUN BOULEVARD, SUITE 310  
BALTIMORE, MARYLAND 21117  
PHONE: 410.265.6100

GENERATOR AND ELECTRICAL EQUIPMENT REPLACEMENT  
**CLARKSBURG ELEMENTARY SCHOOL**  
 13530 REDGRAVE PLACE  
 CLARKSBURG, MD 20871  
 MONTGOMERY COUNTY PUBLIC SCHOOLS

#### VICINITY PLAN

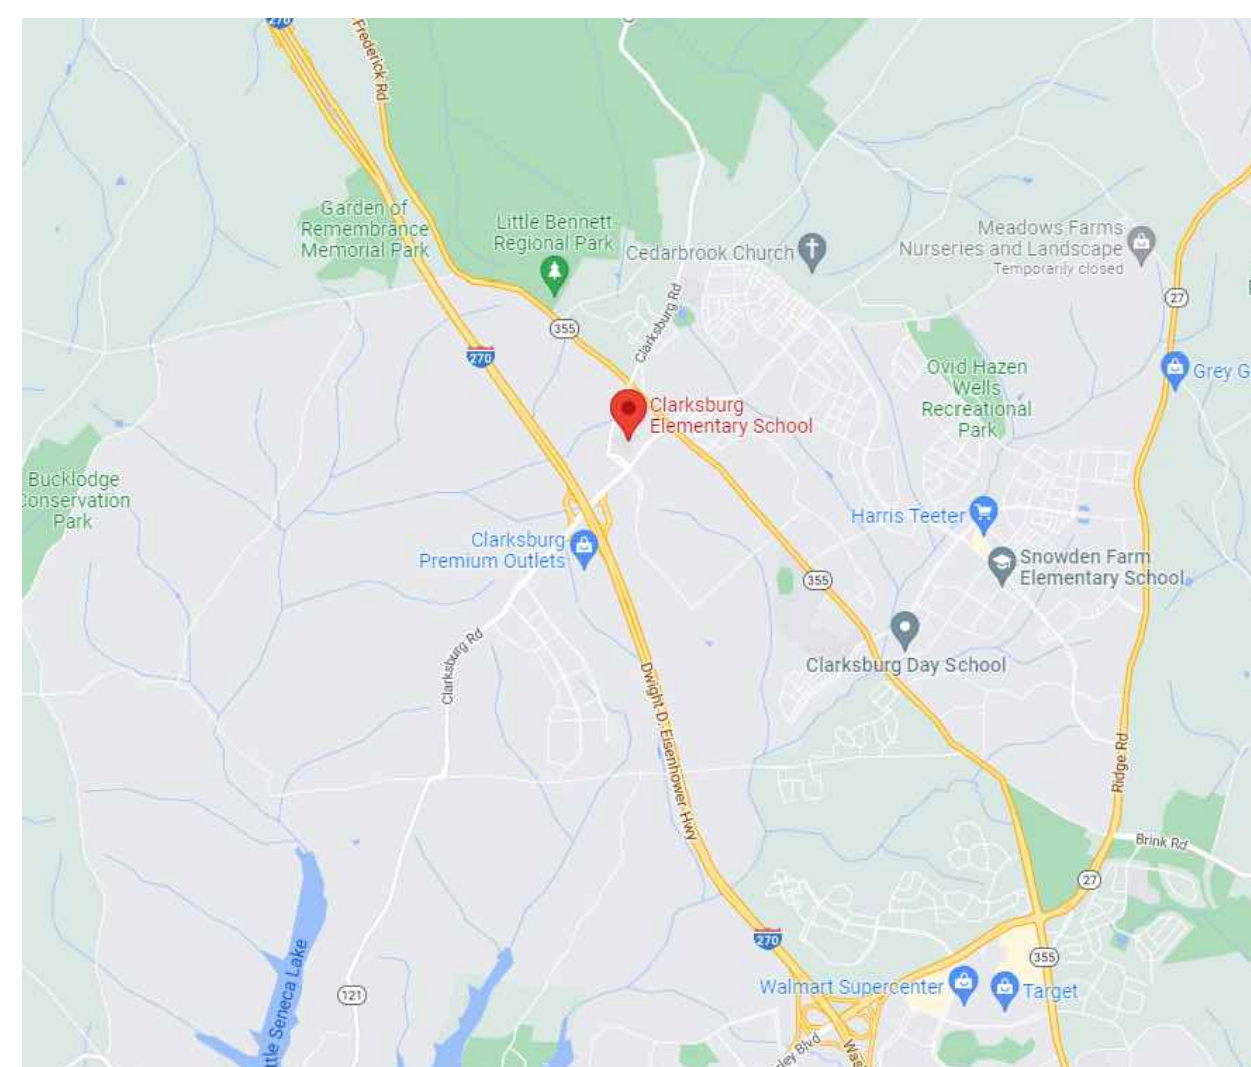

#### AERIAL SITE PLAN

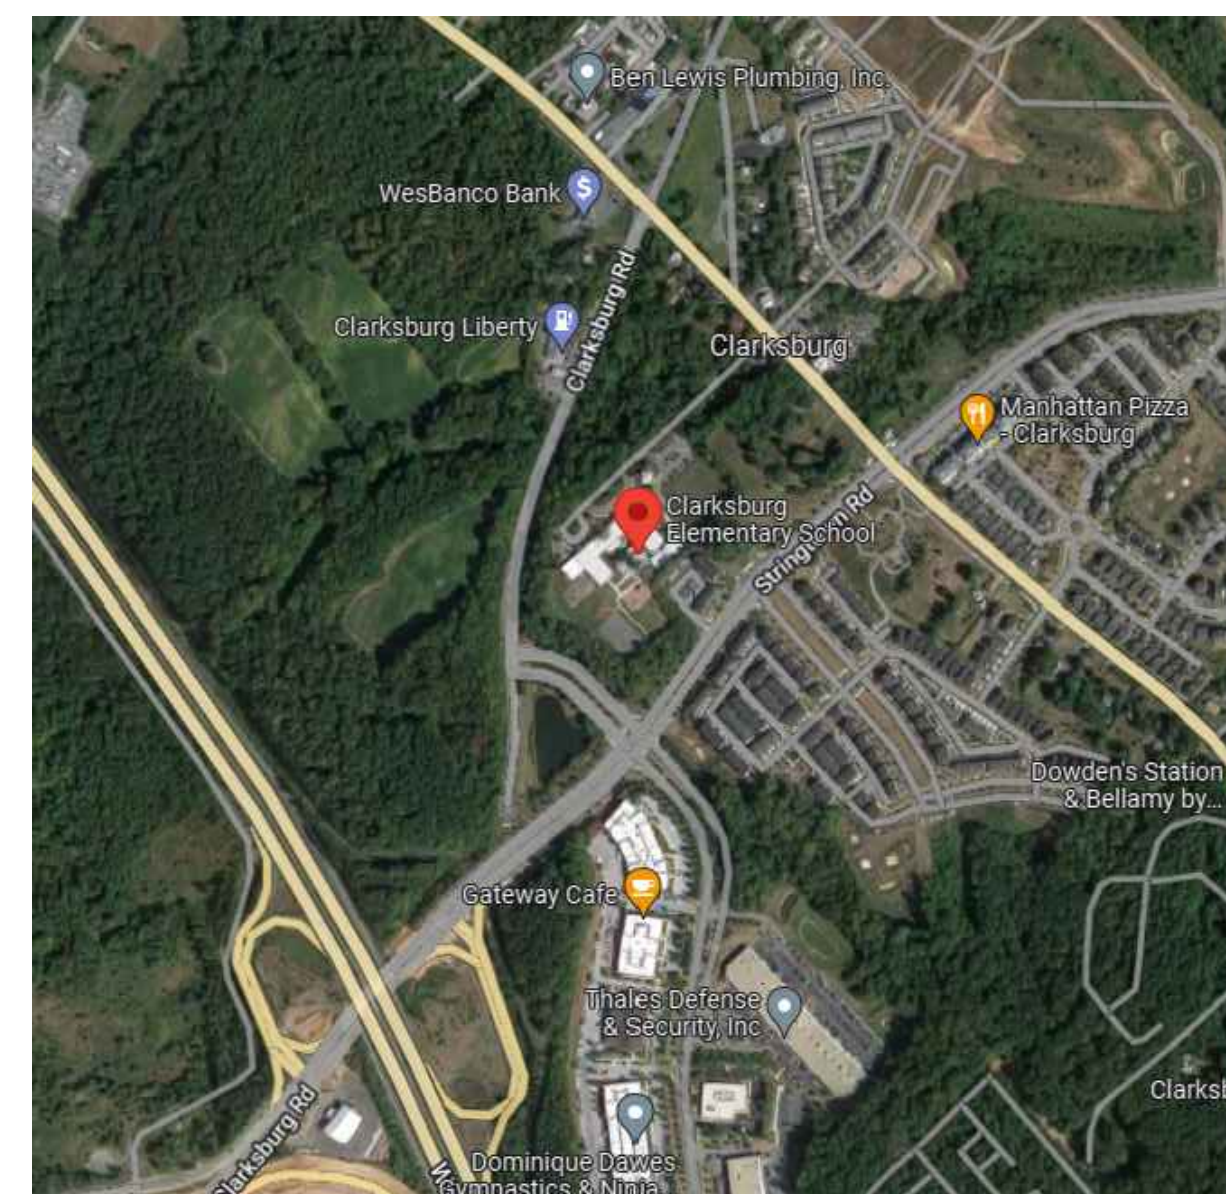

#### DRAWING INDEX

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##### ELECTRICAL


- E-0 SYMBOLS LIST, ABBREVIATIONS, DETAILS AND DIAGRAMS
- E-1 PART FLOOR PLAN - AREA A - DEMOLITION
- E-2 PART FLOOR PLAN - AREA B - DEMOLITION
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#### PROFESSIONAL CERTIFICATION

These contract documents for Clarksburg Elementary School were prepared under my supervision and to the best of my knowledge, information, and belief, they comply with the relevant building codes of the State of Maryland.

02/06/23 (Date)

Maryland Professional Engineer Registration No. 24861

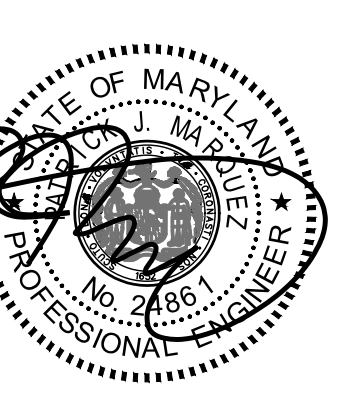

Professional Certification. I hereby certify that these documents were prepared or approved by me, and that I am a duly licensed professional engineer under the laws of the state of Maryland. License No. 24861, Expiration date 02-24-2024.

#### APPLICABLE CODES & STANDARDS

- 2018 IBC: INTERNATIONAL BUILDING CODE
- 2018 IMC: INTERNATIONAL MECHANICAL CODE
- 2018 IPC: INTERNATIONAL PLUMBING CODE WITH WSSC AMENDMENTS
- ASHRAE 90.1: ENERGY STANDARD FOR BUILDINGS EXCEPT LOW RISE RESIDENTIAL BUILDINGS.
- NEC 2017: NATIONAL ELECTRICAL CODE
- ASHRAE 2017-2020 HANDBOOKS.



Engineering Your Vision

Mechanical & Electrical Consulting Engineers

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Baltimore, Maryland 21117

tel 410-265-6100  
jamesposey.com

#### SCOPE OF WORK

SCOPE OF WORK GENERALLY CONSISTS OF THE FOLLOWING OVER TWO PHASES. PHASE 1 SHALL CONSIST OF THE FOLLOWING:

- PROVIDE CONDUITS AND RACEWAYS FOR NEW GENERATOR.
- PROVIDE CONDUITS AND RACEWAYS FOR NEW DEVICES AND CONNECTIONS TO EXISTING EQUIPMENT. FINAL CONNECTIONS TO NEW DEVICES AND EXISTING EQUIPMENT SHALL BE PERFORMED DURING THE SECOND SUMMER.
- PROVIDE NEW CONCRETE PAD FOR NEW GENERATOR.
- CONNECT LIGHTING FIXTURES IN TOILET ROOMS ON NORMAL CIRCUITS TO EXISTING EMERGENCY LIGHTING CIRCUITS, WHERE INDICATED ON DRAWINGS.

PROJECT SCOPE SHALL INCLUDE THE WORK FOR PHASE 2:

- PROVIDE NEW GENERATOR AND ASSOCIATED EQUIPMENT.
- CONNECT EXISTING BOILERS AND ASSOCIATED PUMPS TO THE NEW STANDBY PANELBOARD.
- CONNECT EXISTING KITCHEN REFRIGERATION EQUIPMENT TO NEW STANDBY PANELBOARD.
- CONNECT EXISTING INTERCOMMUNICATIONS/PUBLIC ADDRESS SYSTEM TO THE NEW STANDBY PANELBOARD.
- CONNECT EXISTING MAIN TELECOM ROOM RECEPTACLES TO THE NEW STANDBY PANELBOARD.
- CONNECT NORMAL LIGHTING FIXTURES IN THE MAIN MECHANICAL ROOM/BOILER ROOM AND MAIN ELECTRICAL ROOM TO THE NEW EMERGENCY PANELBOARD.
- CONNECT LIGHTING FIXTURES IN TOILET ROOMS ON NORMAL CIRCUITS TO THE NEW EMERGENCY PANELBOARD, WHERE INDICATED ON DRAWINGS.

THE SCOPE OF WORK INDICATED ON THIS SHEET IS INTENDED AS A BRIEF SUMMARY FOR GENERAL INFORMATIONAL PURPOSES ONLY, AND DOES NOT NECESSARILY INCLUDE ALL OF THE WORK REQUIRED. THE CONTRACTOR SHALL PROVIDE MATERIALS AND LABOR AS REQUIRED TO COMPLETE THE WORK AS INDICATED IN THE CONTRACT DOCUMENTS.


#### BOARD OF EDUCATION

DR. MONIFA B. MCKNIGHT	SUPERINTENDENT
GARY MOSESMAN	DIRECTOR I, DIVISION OF DESIGN & CONSTRUCTION
MS. BRENDA WOLFF	DISTRICT 5
KARLA SILVESTRE	PRESIDENT / AT-LARGE
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JULIE YANG	DISTRICT 3
MRS. REBECCA SMONDROWSKI	DISTRICT 2
MR. ARVIN KIM	STUDENT MEMBER

#### CODE ANALYSIS

CODE ANALYSIS (FROM INTERNATIONAL BUILDING CODE 2018)		
	EXISTING BLDG	PROPOSED ALTERATION
IBC OCCUPANCY CLASSIFICATION	E	THE SCOPE OF THIS WORK IS TO REPLACE EXISTING GENERATOR AND REVISE NORMAL LIGHTING CIRCUITS IN TOILET ROOMS, BOILER ROOM AND ELEC ROOM TO EMERGENCY LIGHTING.
TYPE OF CONSTRUCTION	IIB	THERE IS NO INCREASE IN FLOOR AREA, NO SITE CHANGES, NO CHANGE IN CLASSIFICATION OR TYPE OF CONSTRUCTION.
NUMBER OF STORIES ABOVE GRADE	1	
HIGH RISE (Y/N)	N	
FIRE ALARM (Y/N)	Y	
FULLY SPRINKLERED (Y/N)	Y	
TOTAL BUILDING FLOOR AREA	54,983 SF	

#### GRAPHIC SCALES

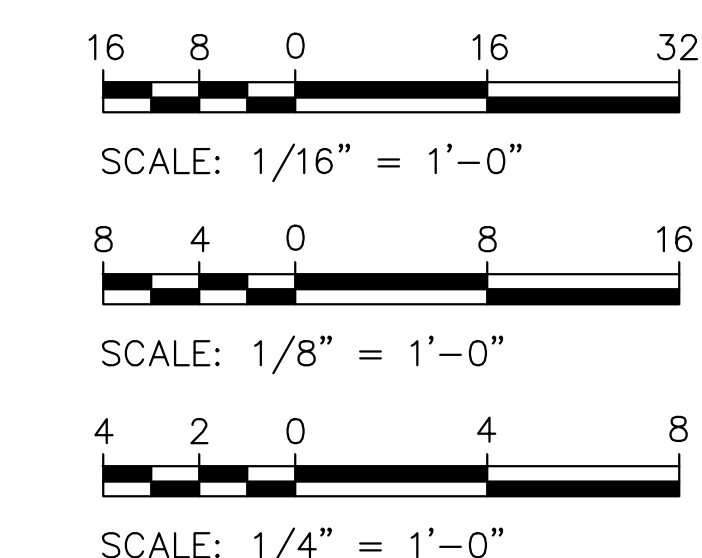

CAUTION: EXCEPT WHERE DIMENSIONS ARE INDICATED, GRAPHIC SCALE MUST BE USED.

Tag	Description	Date
	BID SET	02/06/23

PSC No.

Scale AS NOTED

Project No 7737-22

Date FEBRUARY 6, 2023

Drawing Title


TITLE SHEET

Sheet No:


**T-1**



MECHANICAL SYMBOLS AND ABBREVIATIONS			
— G —	LOW PRESSURE GAS PIPE	Ø	INDICATES DIAMETER
— G (2 PSI) —	MEDIUM PRESSURE GAS PIPE	⊞	ACCESS DOOR
⊞	PIPE CAP OR PLUG	AV	AUTOMATIC AIR VENT
— —	UNION	ABV	ABOVE
⊞	SHUT-OFF VALVE	AFF	ABOVE FINISHED FLOOR
⊞	SOLENOID VALVE	BLDG	BUILDING
⊞	PRESSURE REDUCING / REGULATING VALVE	BLW	BELOW
(M)	METER	BTUH	BRITISH THERMAL UNITS PER HOUR
⊞	GAUGE COCK / TEST PORT	CFH	CUBIC FEET PER HOUR
⊞	CONCENTRIC REDUCER	CFM	CUBIC FEET PER MINUTE
⊞	ECCENTRIC REDUCER	CLG	CEILING
→	FLOW DIRECTION ARROW	CONC	CONCRETE
⊞	STRAINER	CW	DOMESTIC COLD WATER PIPE
●	POINT OF CONNECTION, NEW TO EXISTING	DIA	DIAMETER
●	DEMOLITION WORK TERMINATION POINT	EA	EXHAUST AIR
①	SYMBOL FOR SPECIFIC NOTE. NOTE APPLIES TO DRAWING ON WHICH IT OCCURS.	ETR	EXISTING TO REMAIN
③ / M1	DETAIL OR DIAGRAM NO. 3 SHOWN ON DRAWING M1	EX	EXISTING
		EXH	EXHAUST
		FL	FLOOR
		FT	FEET
		G	GAS PIPE
		GALV	GALVANIZED
		IN	INCH INCHES
		MAX	MAXIMUM
		MBH	THOUSAND BTU'S PER HOUR
		MCPS	MONTGOMERY COUNTY PUBLIC SCHOOLS
		MECH	MECHANICAL
		MFR	MANUFACTURER
		MIN	MINIMUM
		NC	NORMALLY CLOSED
		NIC	NOT IN CONTRACT
		NO	NORMALLY OPEN
		OA	OUTDOOR AIR
		PSI	POUNDS PER SQUARE INCH
		RX	REMOVE EXISTING
		TYP	TYPICAL
		UON	UNLESS OTHERWISE NOTED

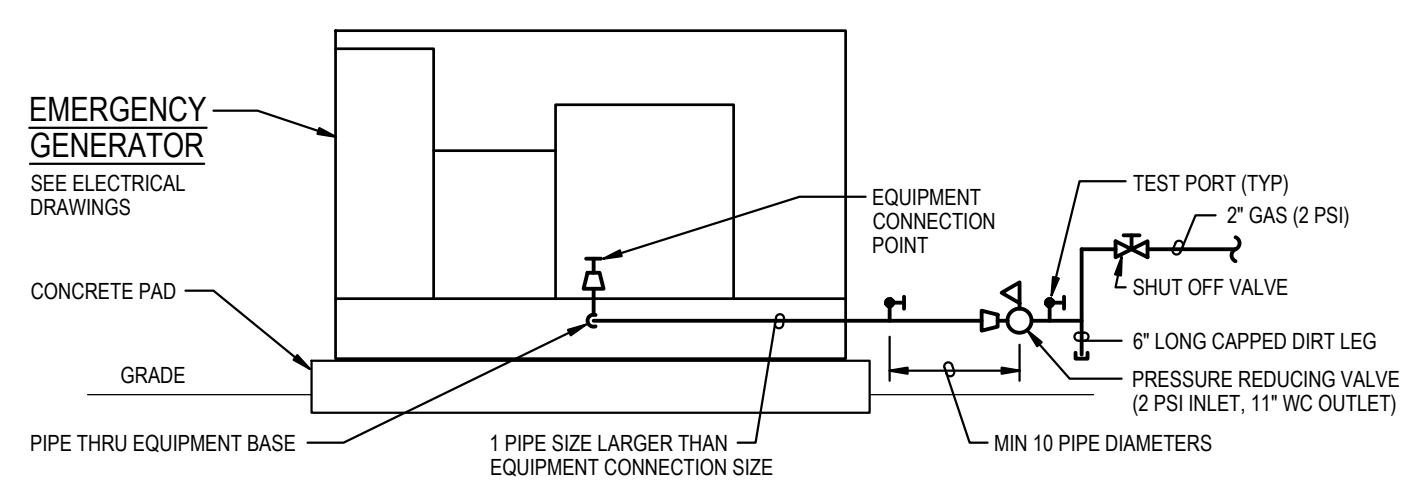

**DIAGRAM 1**  
**EQUIPMENT CONNECTION**  
 NOT TO SCALE

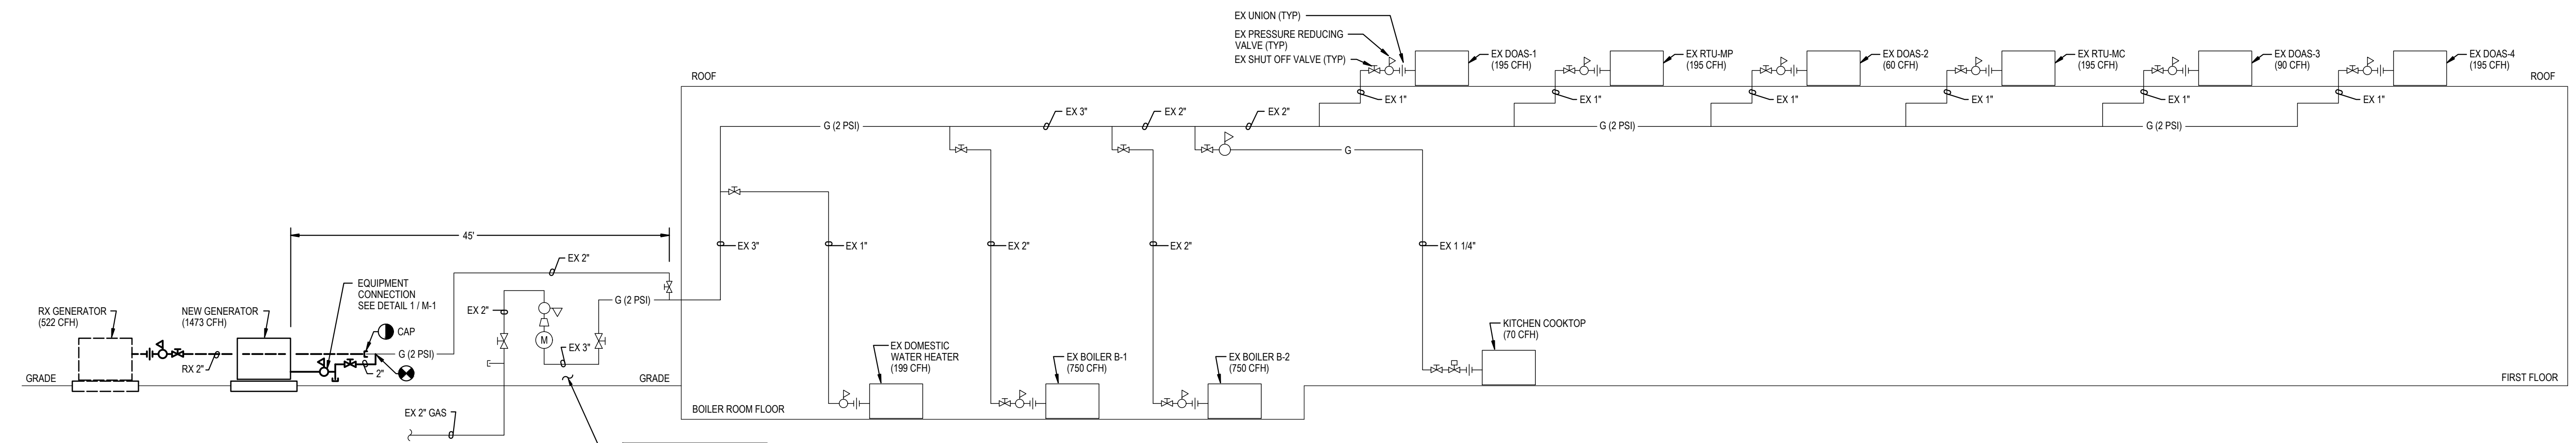

ABOVE GROUND PIPE: SCHEDULE 40 STEEL PIPE  
 PIPE AND VENT REGULATORS PER IFGC 2018  
 406.410.2 AND 410.3

**DIAGRAM 2**  
**GAS RISER**  
 NOT TO SCALE



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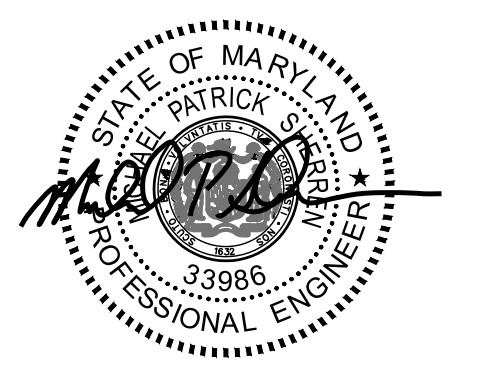
Drawing Title  
**DIAGRAMS, SYMBOLS AND ABBREVIATIONS**

Sheet No:  
**M-1**



- GENERAL NOTES:**
- A. INFORMATION SHOWN ON THIS DRAWING PERTAINING TO EXISTING CONDITIONS HAS BEEN OBTAINED FROM AVAILABLE BUILDING DRAWINGS OR GENERAL FIELD OBSERVATIONS AND MAY NOT INDICATE EXISTING CONDITIONS IN DETAIL OR DIMENSION. DETERMINE EXISTING CONDITIONS PRIOR TO FABRICATION OR PERFORMANCE OF ANY WORK. SHOULD CONDITIONS BE DISCOVERED THAT PREVENT EXECUTION OF THE WORK AS INDICATED, IMMEDIATELY NOTIFY THE ENGINEER IN WRITING AND AWAIT DIRECTION BEFORE PROCEEDING WITH THE WORK.
  - B. DEMOLITION SHALL INCLUDE REMOVAL AND OFF-SITE DISPOSAL OF MATERIALS. DO NOT ABANDON IN PLACE ANY MECHANICAL AND RELATED ELECTRICAL COMPONENTS UNLESS OTHERWISE NOTED ON DRAWINGS.
  - C. UNLESS OTHERWISE NOTED, MECHANICAL/PLUMBING ITEMS SHOWN HEAVY DASHED (---) SHALL BE REMOVED AND MECHANICAL/PLUMBING ITEMS SHOWN LIGHT SOLID (—) SHALL REMAIN.
  - D. NEW GENERATOR AND GAS PIPING TO BE INSTALLED BEFORE EXISTING IS REMOVED. REFER TO ELECTRICAL DRAWINGS FOR ADDITIONAL PHASING INFORMATION.

GENERATOR AND ELECTRICAL EQUIPMENT REPLACEMENT  
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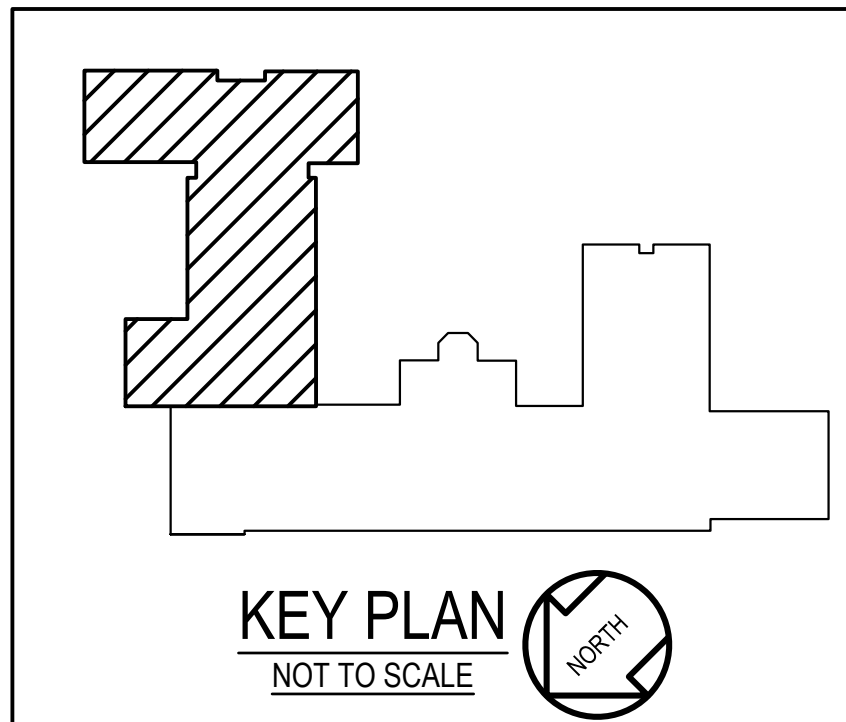
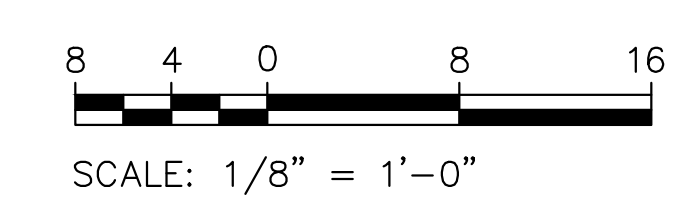
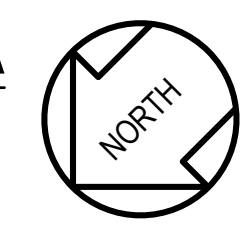
Tag	Description	Date
	BID SET	02/06/23

PSC No.	
Scale	AS NOTED
Project No.	7737-22
Date	FEBRUARY 6, 2023

Drawing Title  
**PART FLOOR PLAN AREA A DEMOLITION**

Sheet No:  
**M-2**



1 PART FLOOR PLAN - AREA A  
 M-2 DEMOLITION  
 SCALE: 1/8" = 1'-0"








**GENERAL NOTES:**


- A. INFORMATION SHOWN ON THIS DRAWING PERTAINING TO EXISTING CONDITIONS HAS BEEN OBTAINED FROM AVAILABLE BUILDING DRAWINGS OR GENERAL FIELD OBSERVATIONS AND MAY NOT INDICATE EXISTING CONDITIONS IN DETAIL OR DIMENSION. DETERMINE EXISTING CONDITIONS PRIOR TO FABRICATION OR PERFORMANCE OF ANY WORK. SHOULD CONDITIONS BE DISCOVERED THAT PREVENT EXECUTION OF THE WORK AS INDICATED, IMMEDIATELY NOTIFY THE ENGINEER IN WRITING AND AWAIT DIRECTION BEFORE PROCEEDING WITH THE WORK.
- B. DO NOT LOCATE PIPING ABOVE ELECTRICAL PANELS OR EQUIPMENT.
- C. UNLESS OTHERWISE NOTED, MECHANICAL/PLUMBING ITEMS SHOWN HEAVY ( ) SHALL BE NEW AND MECHANICAL/PLUMBING ITEMS SHOWN LIGHT ( ) ARE EXISTING TO REMAIN.
- D. NEW GENERATOR AND GAS PIPING TO BE INSTALLED BEFORE EXISTING IS REMOVED. REFER TO ELECTRICAL DRAWINGS FOR ADDITIONAL PHASING INFORMATION.

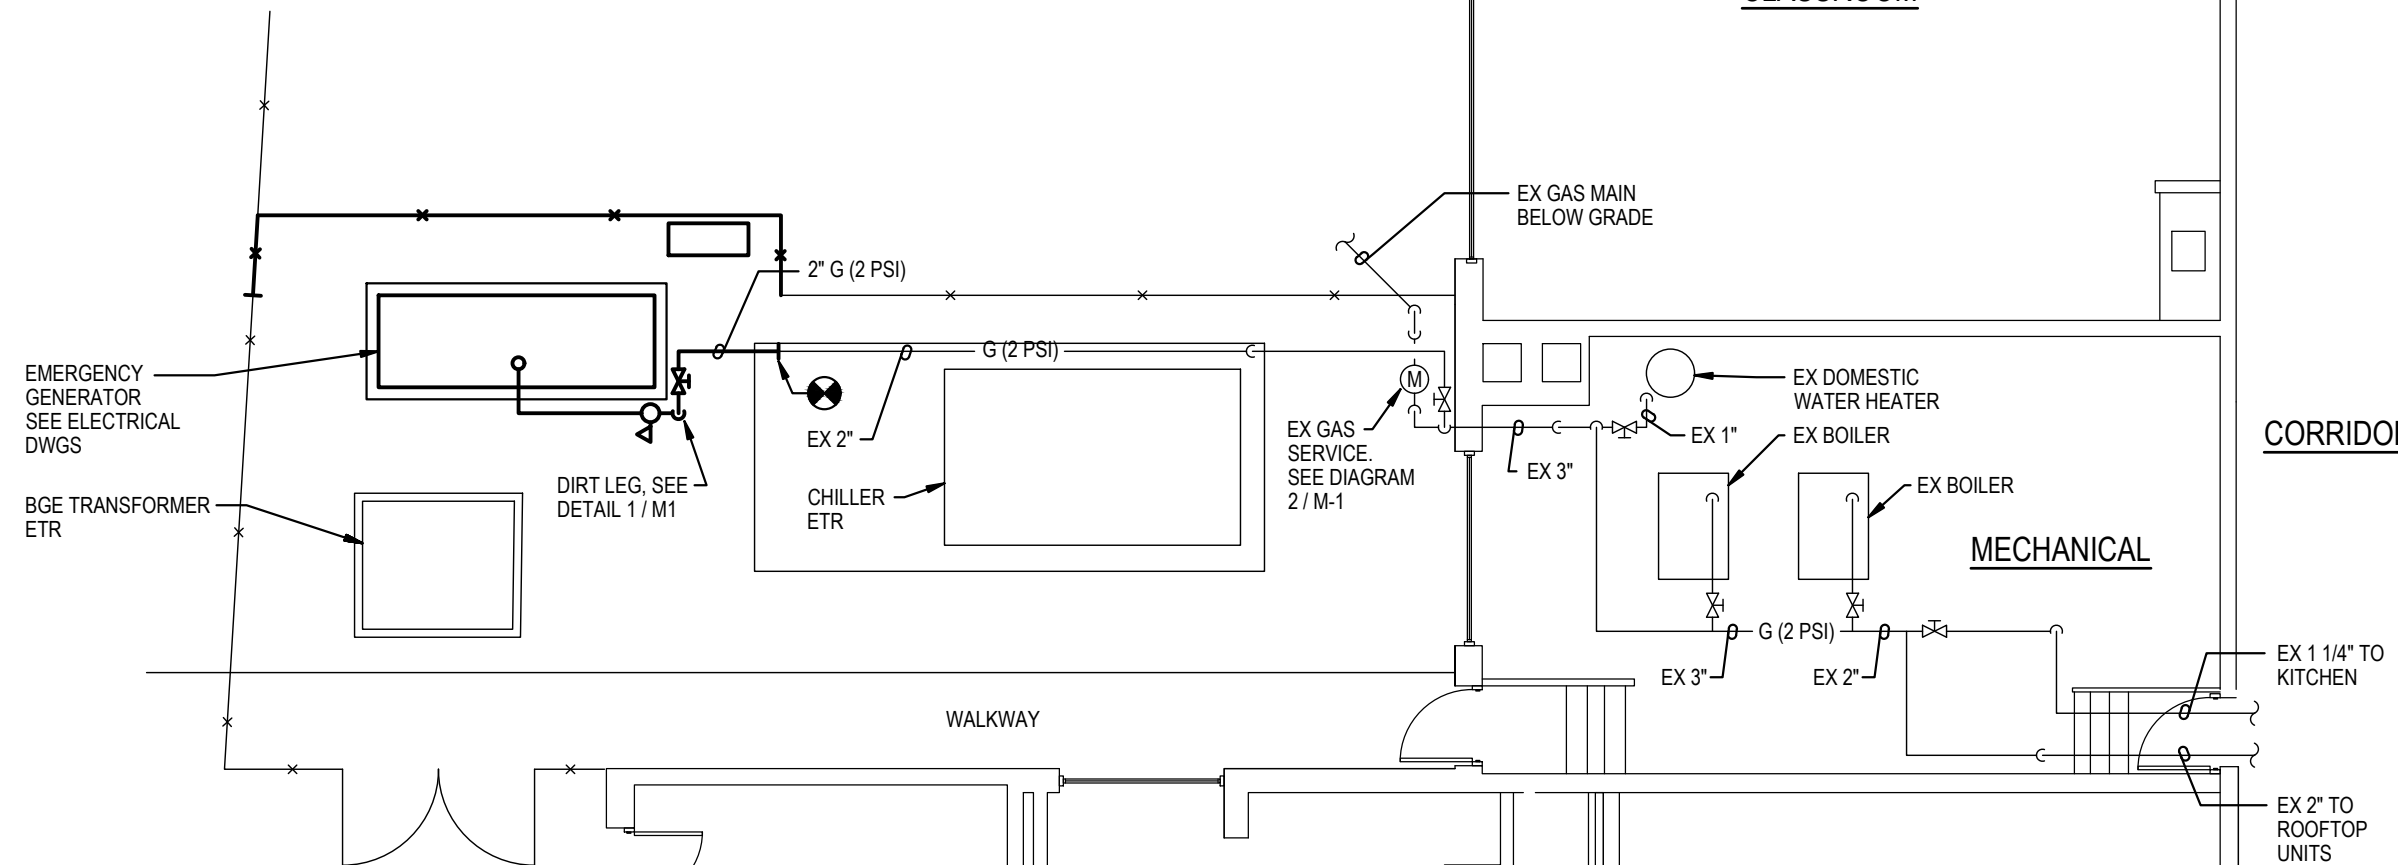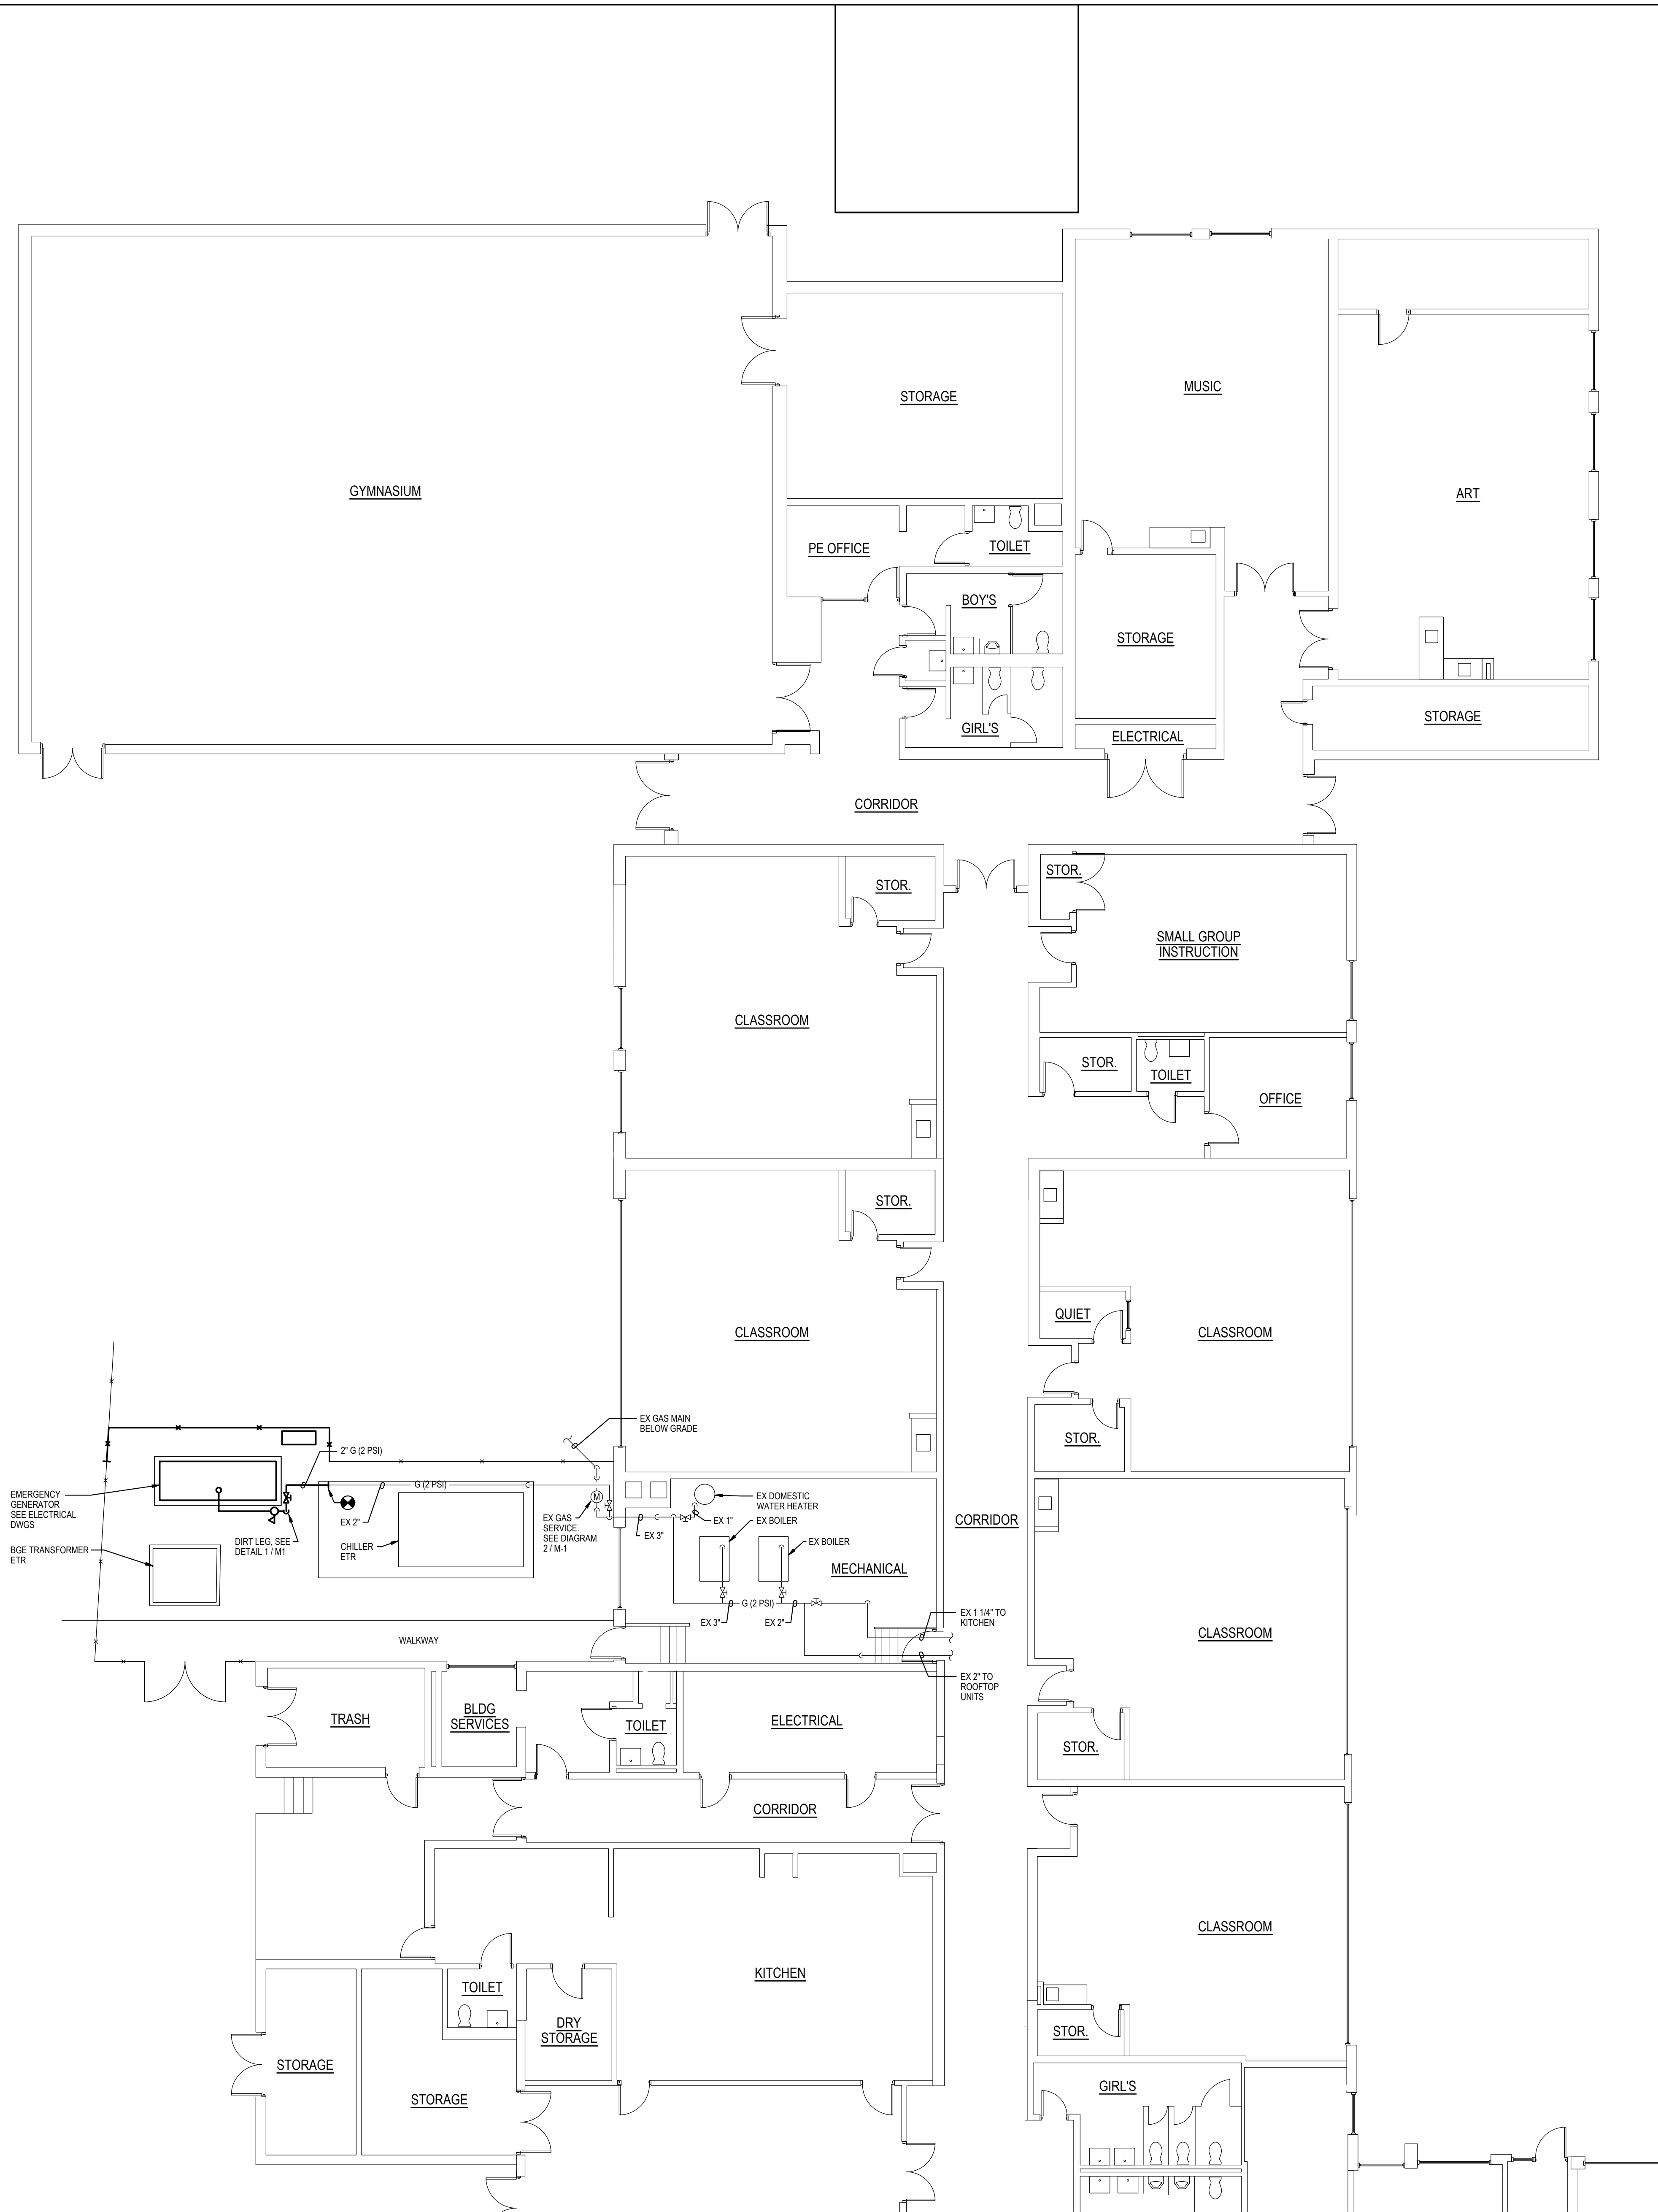

1 PART FLOOR PLAN - AREA A  
M-3 NEW WORK  
SCALE: 1/8" = 1'-0"

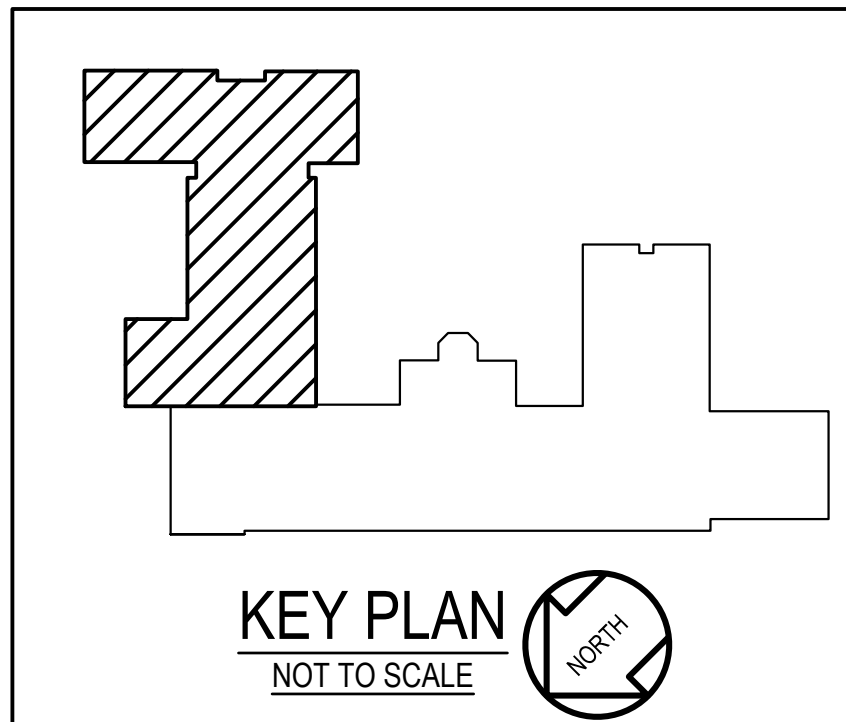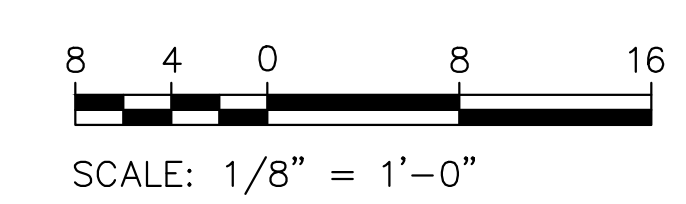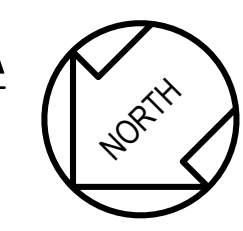

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Drawing Title  
**PART FLOOR PLAN AREA A NEW WORK**

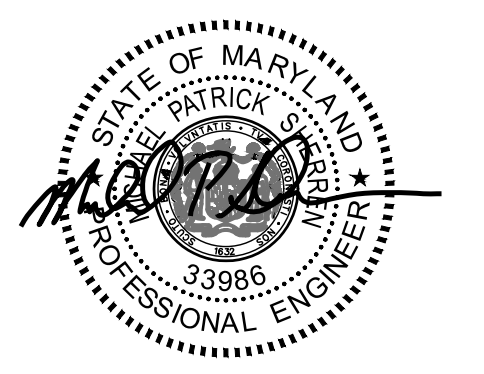Sheet No:  
**M-3**





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Tag	Description	Date
	BID SET	02/06/23
PSC No.		
Scale	AS NOTED	
Project No.	7737-22	
Date	FEBRUARY 6, 2023	
Drawing Title	SYMBOLS LIST, ABBREVIATIONS, DETAILS AND DIAGRAMS	
Sheet No.	E-0	

**ELECTRICAL SYMBOLS AND ABBREVIATIONS**

**GENERAL**

- ① DENOTES REFERENCE TO SPECIFIC NOTE ON DRAWING.
- Ⓛ DETAIL, DIAGRAM OR PLAN NUMBER
- Ⓛ E-0 DRAWING NUMBER WHERE DETAIL, DIAGRAM OR PLAN IS LOCATED.
- #E-# DETAIL, DIAGRAM OR PLAN REFERENCE: DETAIL, DIAGRAM OR PLAN NUMBER/DRAWING NUMBER

**NOTES:**

- A. PROVIDE DEDICATED NEUTRAL CONDUCTOR FOR EACH BRANCH CIRCUIT.
- B. THE EXISTING FACILITY WILL REMAIN IN OPERATION DURING RENOVATION. INTERRUPTION TO THE EXISTING BUILDING ELECTRIC SERVICE SHALL BE COORDINATED WITH THE USER TO MINIMIZE DISRUPTION. INTERRUPTION OF UTILITIES SHALL NOT OCCUR DURING SCHOOL WORK HOURS.

**DEMOLITION**

- DISCONNECT AND REMOVE EXISTING WIRING IN CONDUIT, UNLESS OTHERWISE NOTED.
- DISCONNECT AND REMOVE EXISTING HOMERUN WIRING IN CONDUIT BACK TO SOURCE.
- DISCONNECT AND REMOVE PANELBOARD OR CABINET AS INDICATED.
- DISCONNECT AND REMOVE TRANSFORMER, INCLUDING HOUSEKEEPING PAD.
- DISCONNECT AND REMOVE ENCLOSED SWITCH (DISCONNECT/SAFETY SWITCH).
- DISCONNECT AND REMOVE EXISTING DUPLEX OR DOUBLE-DUPLEX (QUAD) RECEPTACLE.

**EXISTING**


- EXISTING TO REMAIN WALL OUTLET AND LIGHTING FIXTURE.
- EXISTING TO REMAIN CEILING OUTLET AND LIGHTING FIXTURE.
- EXISTING TO REMAIN WALL OUTLET AND LIGHTING FIXTURE PREVIOUSLY ON NORMAL POWER CIRCUIT AND CHANGED TO GENERATOR POWER CIRCUIT.
- EXISTING TO REMAIN CEILING OUTLET AND LIGHTING FIXTURE ON GENERATOR POWER CIRCUIT, OR PREVIOUSLY ON NORMAL POWER CIRCUIT AND CHANGED TO GENERATOR POWER CIRCUIT.
- EXISTING TO REMAIN WALL MOUNTED SWITCH.
- EXISTING TO REMAIN 277/480 OR 120/208V PANELBOARD, SURFACE MOUNTED.
- EXISTING TO REMAIN TRANSFORMER.
- EXISTING TO REMAIN WIRING IN CONDUIT.
- EXISTING TO REMAIN WIRING IN CONDUIT CONTINUED.
- EXISTING TO REMAIN WIRING IN CONDUIT TURNING DOWN.
- EXISTING TO REMAIN HOMERUN WIRING IN CONDUIT BACK TO SOURCE.
- EXISTING TO REMAIN WALL MOUNTED JUNCTION BOX.
- EXISTING TO REMAIN MOTOR CONNECTION.
- EXISTING EQUIPMENT CONNECTION TO BE RECONNECTED WHERE INDICATED.
- EXISTING TO REMAIN ENCLOSED SWITCH (DISCONNECT/SAFETY SWITCH).
- EXISTING TO REMAIN MOTOR STARTER.
- EXISTING TO REMAIN VARIABLE FREQUENCY DRIVE.
- EXISTING TO REMAIN DUPLEX RECEPTACLE.
- EXISTING TO REMAIN QUADRUPLEX (DOUBLE-DUPLEX) RECEPTACLE.

**POWER**


- HOMERUN TO PANELBOARD. NUMBER OF HASH MARKS INDICATES NUMBER OF WIRES PLUS GROUND WIRE. REFER TO PANEL SCHEDULES FOR CONDUCTOR SIZES. PROVIDE GROUND WIRES IN CONDUITS.
- HOMERUN TO PANELBOARD, RUN BELOW GRADE. NUMBER OF HASH MARKS INDICATES NUMBER OF WIRES PLUS GROUND WIRE. REFER TO PANEL SCHEDULES FOR CONDUCTOR SIZES. PROVIDE GROUND WIRES IN CONDUITS.
- WIRING IN CONDUIT RUN CONCEALED IN CEILING SPACE ABOVE CEILINGS AND EXPOSED IN OPEN CEILINGS, UNLESS OTHERWISE NOTED. WIRING IN CONDUIT DESIGNATED WITH "EM" DENOTE EMERGENCY LIGHTING CIRCUIT. PROVIDE GROUND WIRES IN CONDUITS.
- WIRING IN CONDUIT RUN BELOW GRADE OR BELOW ROOF.
- JUNCTION BOX WITH BLANK COVER PLATE.
- ELECTRIC PANELBOARD (277/480V), SURFACE MOUNTED.
- TRANSFORMER.
- ELECTRIC PANELBOARD (120/208V), SURFACE MOUNTED.
- EQUIPMENT CABINET AS NOTED.
- AUTOMATIC TRANSFER SWITCH.
- ENCLOSED CIRCUIT BREAKER.
- ENCLOSED SWITCH (DISCONNECT/SAFETY SWITCH) IN NEMA TYPE 1 ENCLOSURE, UNLESS OTHERWISE NOTED. MOUNT 5'-6" ABOVE FLOOR TO TOP OF ENCLOSURE, UNLESS OTHERWISE NOTED. RATING AND FUSING AS INDICATED.
- MOTOR CONNECTION.
- HARD-WIRED ELECTRICAL CONNECTION. CONNECT TO EQUIPMENT AS NOTED.
- SURGE PROTECTIVE DEVICE IN NEMA TYPE 1 ENCLOSURE, UNLESS OTHERWISE NOTED.
- DUPLEX RECEPTACLE (NEMA 5-20R) ON GENERATOR STANDBY POWER CIRCUIT, SURFACE WALL-MOUNTED 16" ABOVE FLOOR TO BOTTOM OF BOX.
- DUPLEX RECEPTACLE (NEMA 5-20R) ON GENERATOR STANDBY POWER CIRCUIT, SURFACE WALL-MOUNTED 48" ABOVE FLOOR TO TOP OF BOX. RECEPTACLES DESIGNATED WITH A "WP" SHALL BE WEATHER-RESISTANT AND GROUND FAULT CIRCUIT INTERRUPTER (GFCI) TYPE RECEPTACLE (NEMA 5-20R) WITH WEATHERPROOF WHILE-IN-USE COVER. RECEPTACLES DESIGNATED WITH A "H" SHALL BE SHALL BE HOSPITAL GRADE TYPE.
- DOUBLE-DUPLEX (QUADRUPLEX) RECEPTACLE (NEMA 5-20R) ON GENERATOR STANDBY POWER CIRCUIT, SURFACE WALL-MOUNTED 48" ABOVE FLOOR TO TOP OF BOX.

**FIRE DETECTION AND ALARM**


- MONITORING MODULES. PROVIDE FIRE ALARM WIRING IN CONDUIT AND CONNECT MONITORING MODULES TO EXISTING FIRE DETECTION AND ALARM SYSTEM FOR "GENERATOR RUN" AND "GENERATOR FAULT". MAKE CONNECTIONS NECESSARY FOR COMPLETE INSTALLATION. RE-PROGRAM FIRE ALARM CONTROL PANEL AS REQUIRED.

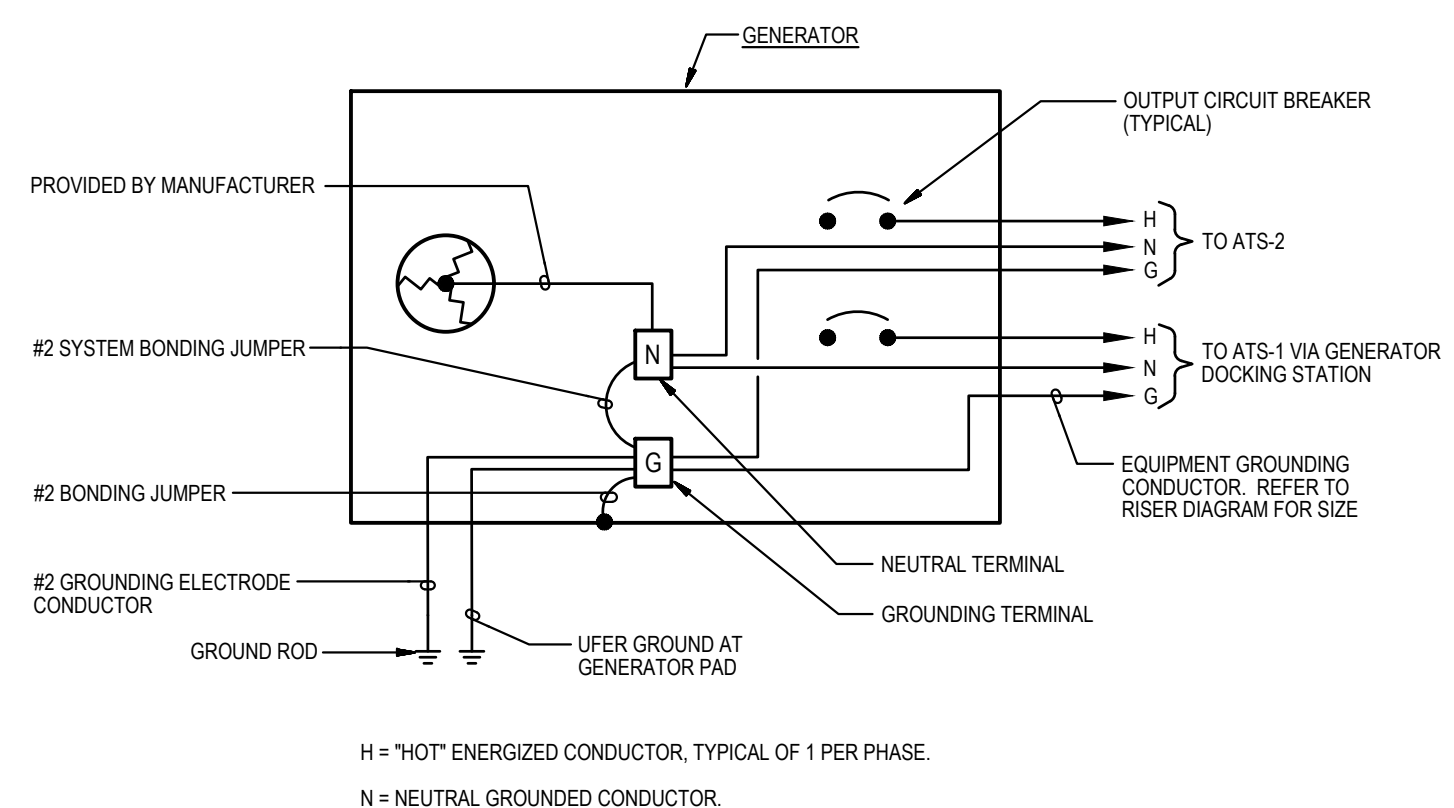

**3**  
E-0 **DIAGRAM**  
GENERATOR GROUNDING WIRING  
NOT TO SCALE

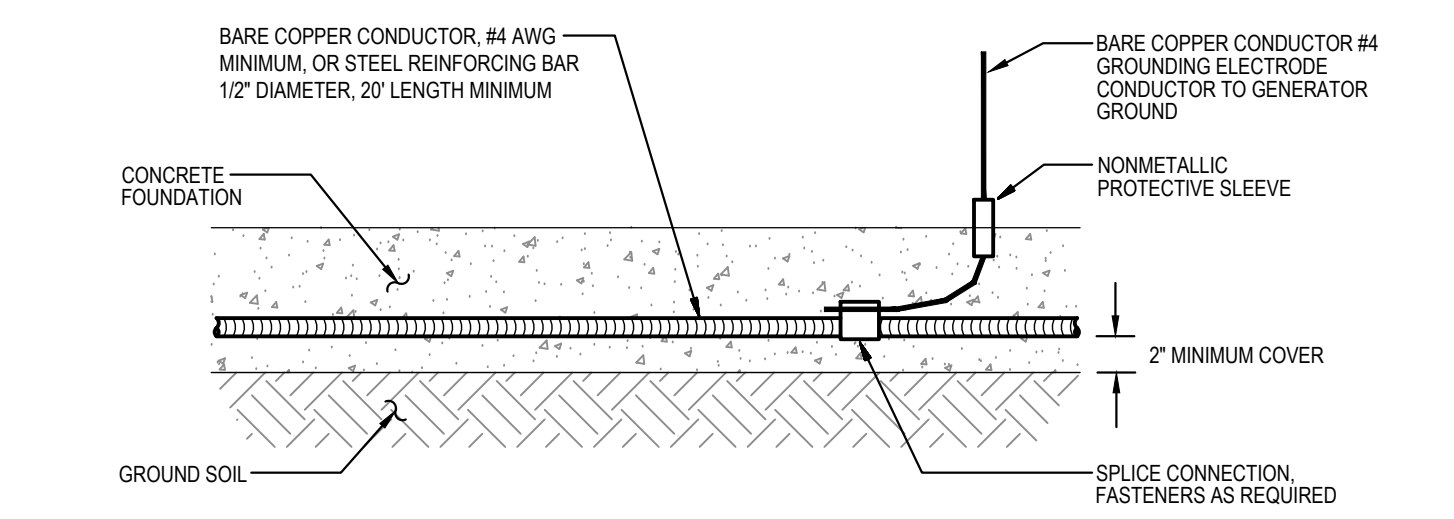


**2**  
E-0 **DETAIL**  
TYPICAL UFER GROUND  
NOT TO SCALE

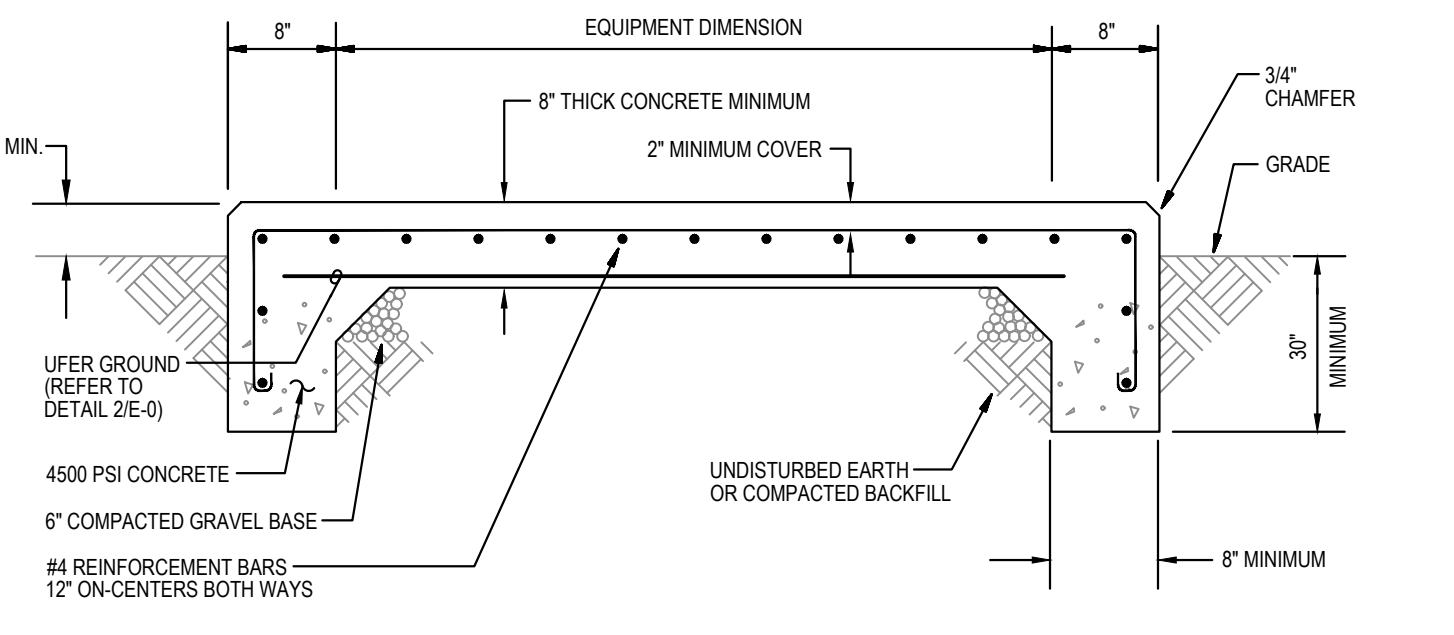


**1**  
E-0 **DETAIL**  
GENERATOR CONCRETE PAD  
NOT TO SCALE

**ABBREVIATIONS**

A, AMP	AMPERE(S)	MCPS	MONTGOMERY COUNTY
AIC	AMPERES INTERRUPTING CAPACITY	MIN	MINIMUM
ATS	AUTOMATIC TRANSFER SWITCH	N	NEUTRAL
C	CONDUIT	NEMA	NATIONAL ELECTRICAL MANUFACTURERS ASSOCIATION
CB	CIRCUIT BREAKER	P	POLE(S) OR PUMP
CKT	CIRCUIT	PA	PUBLIC ADDRESS
CT	CURRENT TRANSFORMERS	PSI	POUNDS PER SQUARE INCH
DIST	DISTRIBUTION	PVC	POLYVINYL CHLORIDE
EM	EMERGENCY	REC	RECEPTACLE
ETR	EXISTING TO REMAIN	REFRIG	REFRIGERATOR
EX	EXISTING	RX	REMOVE EXISTING
FAAP	FIRE ALARM ANNUNCIATOR PANEL	SPD	SURGE PROTECTIVE DEVICE
FACP	FIRE ALARM CONTROL PANEL	STOR	STORAGE
G	GROUND	V	VOLT(S)
GFCI	GROUND FAULT CIRCUIT INTERRUPTER	VFD	VARIABLE FREQUENCY DRIVE
H	HOT	W	WIRE(S)
HP	HORSEPOWER	XFMR	TRANSFORMER
KVA	KILOVOLT-AMPERES	Ø	PHASE
KW	KILOWATTS		
LTG	LIGHTING		

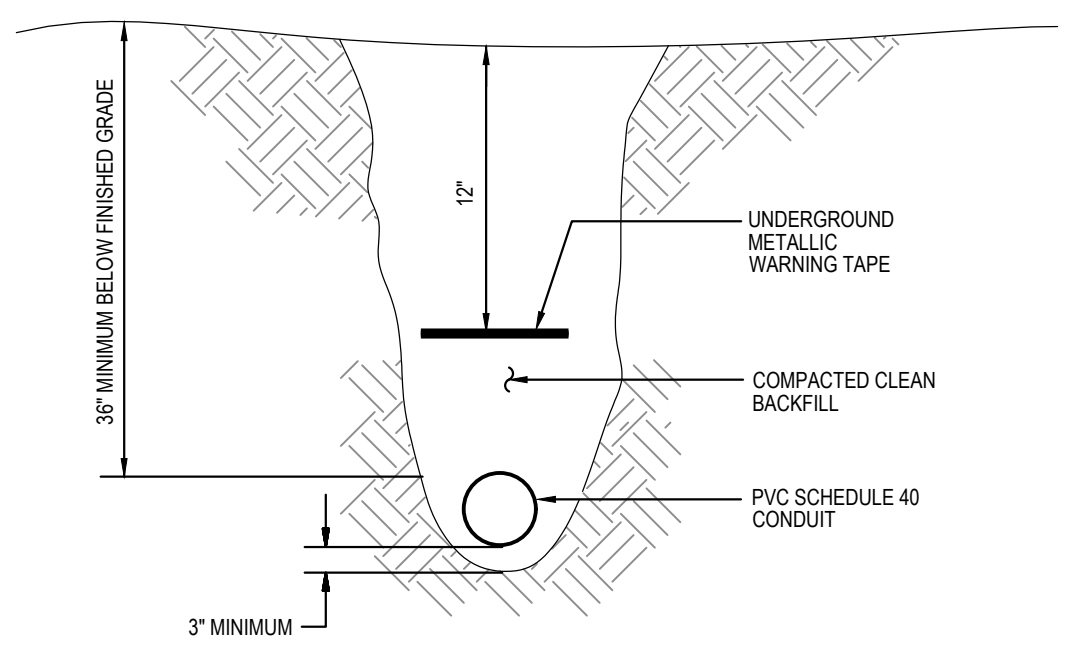

**8**  
E-0 **DETAIL**  
DIRECTLY-BURIED CONDUIT  
NOT TO SCALE

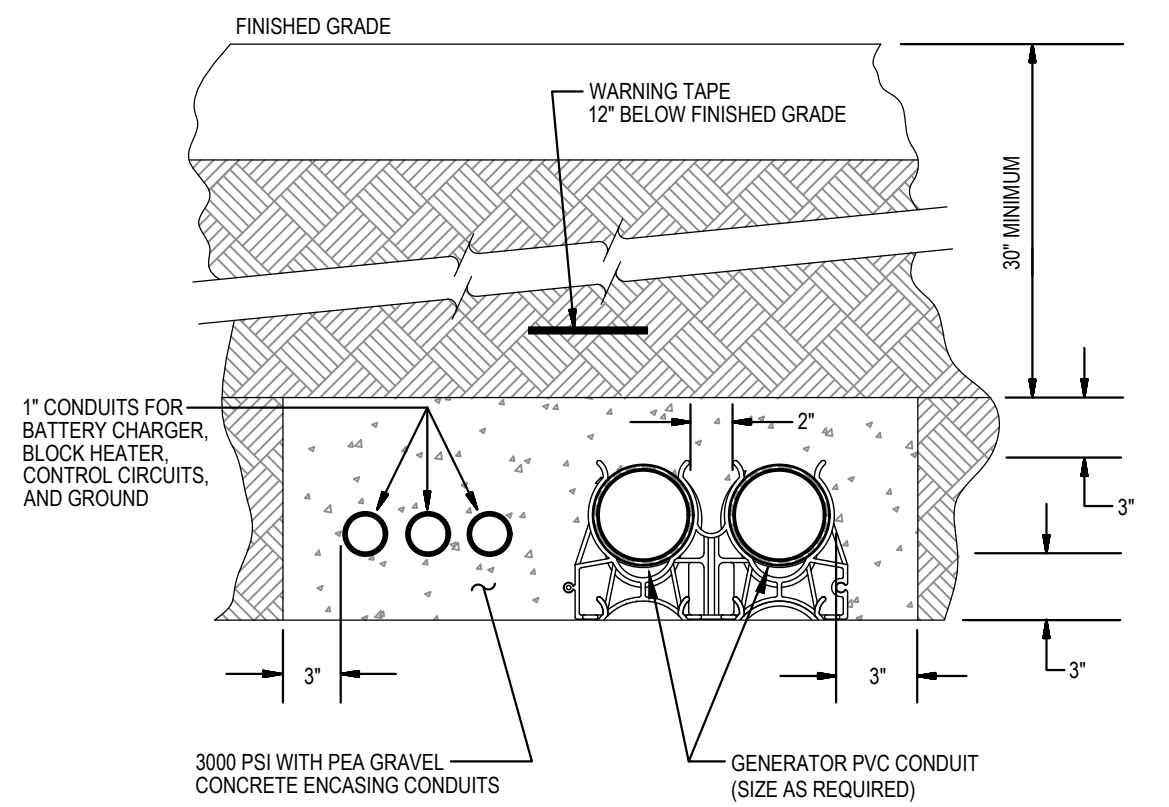

**7**  
E-0 **DETAIL**  
GENERATOR DUCTBANK  
NOT TO SCALE

**GENERATOR DOCKING STATION**  
 FOR CONNECTIONS TO A TEMPORARY PORTABLE GENERATOR  
 CONFIGURE TEMPORARY PORTABLE GENERATOR WITH GENERATOR NEUTRAL CONNECTED TO GENERATOR GROUND. GENERATOR SHALL BE A SEPARATELY DERIVED SYSTEM.


MECHANICALLY FASTEN SIGN TO FRONT OF GENERATOR DOCKING STATION

**6**  
E-0 **DETAIL**  
PLACARD AT GENERATOR DOCKING STATION  
NOT TO SCALE


**EMERGENCY AND STANDBY POWER**  
 125KW, 277/480 VOLTS, 3-PHASE, 4-WIRE  
 NATURAL GAS GENERATOR  
 LOCATED OUTDOORS  
 NEXT TO LOADING DOCK AND  
 MECHANICAL ROOM

MECHANICALLY FASTEN SIGN TO FRONT OF MAIN SWITCHBOARD

**5**  
E-0 **DETAIL**  
PLACARD AT MAIN SERVICE  
NOT TO SCALE

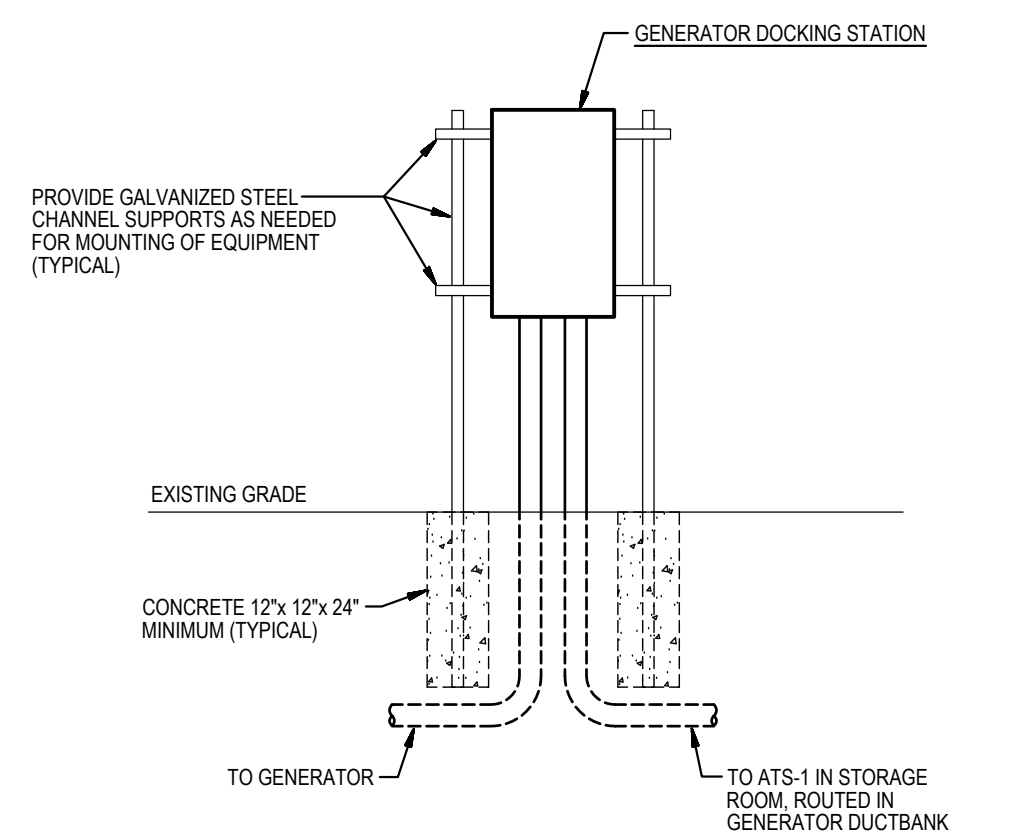


**10**  
E-0 **DETAIL**  
ELECTRICAL EQUIPMENT ELEVATION  
NOT TO SCALE

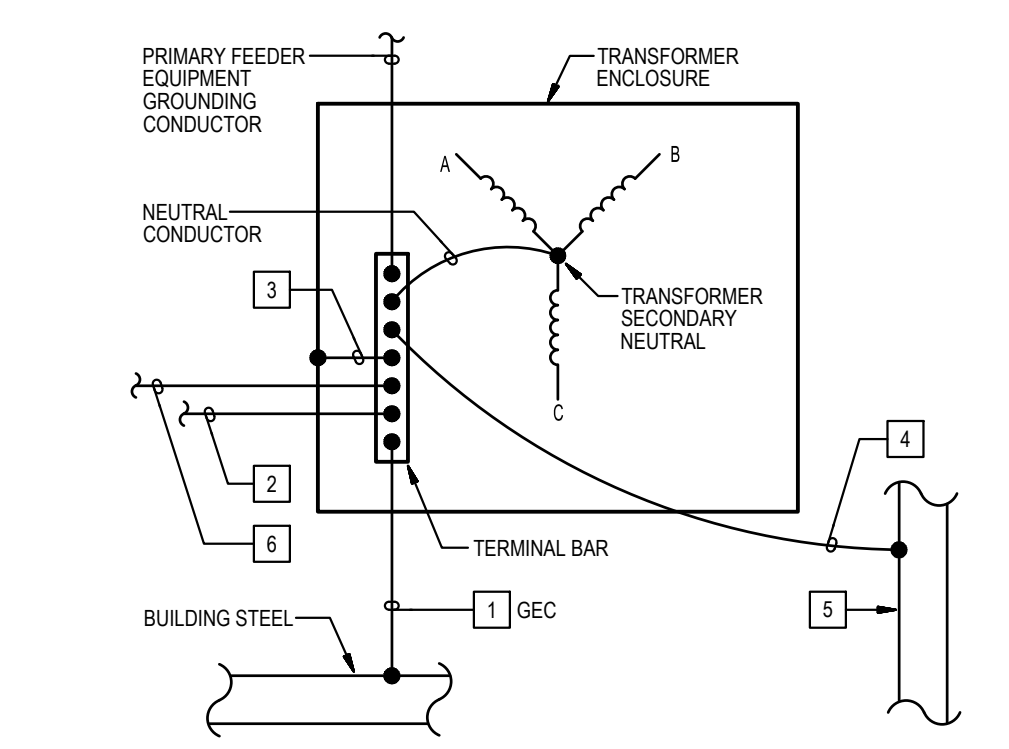




- DETAIL NOTES:**
- 1 GROUNDING ELECTRODE CONDUCTOR (GEC), SIZED PER SCHEDULE OF TRANSFORMERS ON DRAWING E7.
  - 2 SUPPLY-SIDE BONDING JUMPER, 2017 NEC TABLE 250.102(C)(1), SIZED PER SCHEDULE OF TRANSFORMERS ON DRAWING E7, TO EQUIPMENT GROUND BAR OF PANELBOARD SUPPLIED BY TRANSFORMER.
  - 3 SYSTEM BONDING JUMPER, SIZED PER SUPPLY-SIDE BONDING JUMPER.
  - 4 SYSTEM BONDING CONDUCTOR, SIZED PER PER SUPPLY-SIDE BONDING JUMPER.
  - 5 METAL WATER PIPING SYSTEM (TYPICAL FOR EACH SYSTEM IN AREA SERVED BY TRANSFORMER).
  - 6 NEUTRAL CONDUCTOR, TO NEUTRAL BUS BAR (ISOLATED NEUTRAL TERMINAL) OF PANELBOARD SUPPLIED BY TRANSFORMER.

**9**  
E-0 **DETAIL**  
TRANSFORMER GROUNDING & BONDING  
NOT TO SCALE

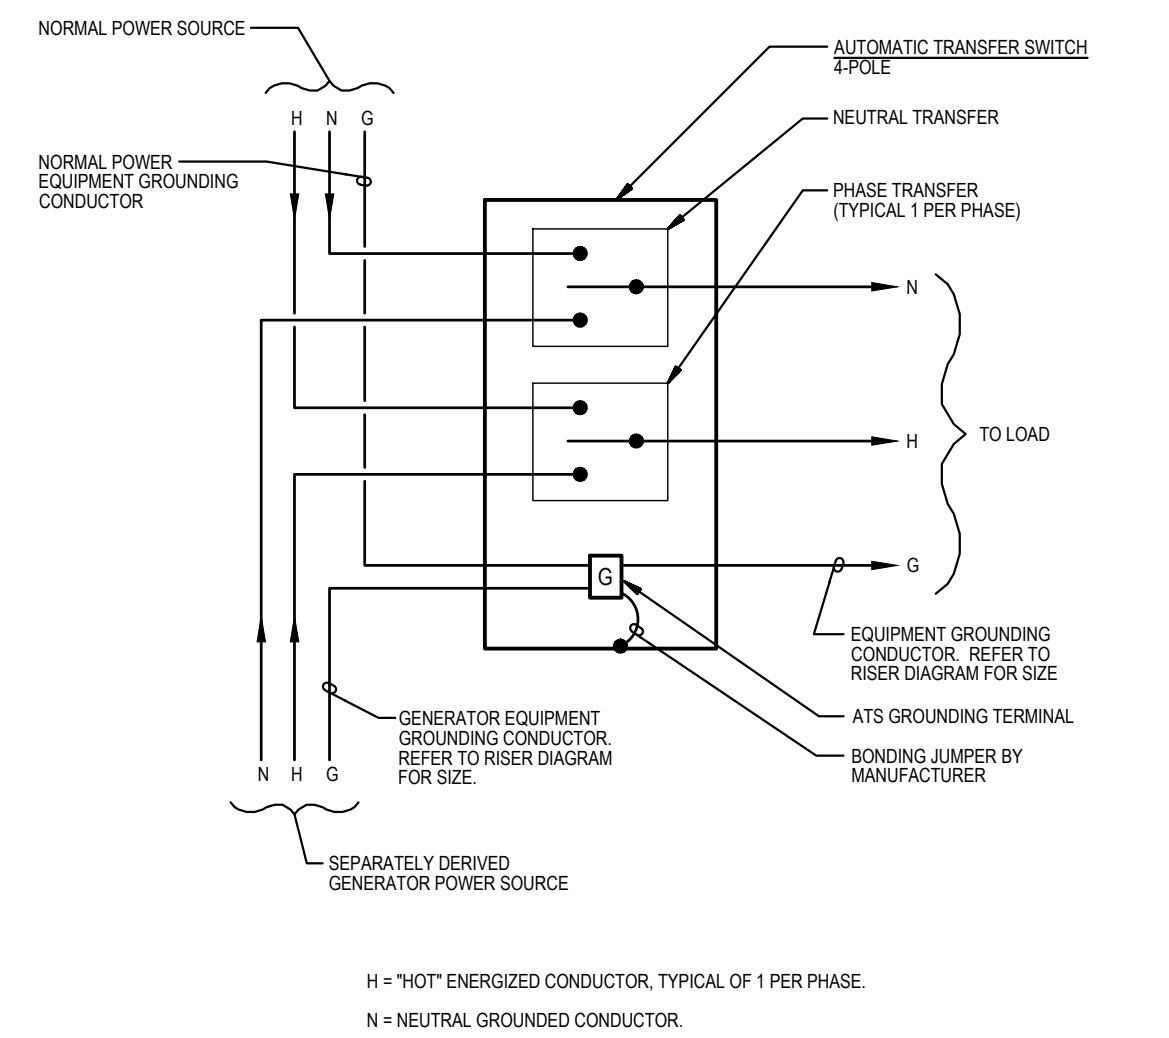


**4**  
E-0 **DIAGRAM**  
AUTOMATIC TRANSFER SWITCH GROUND WIRING  
NOT TO SCALE





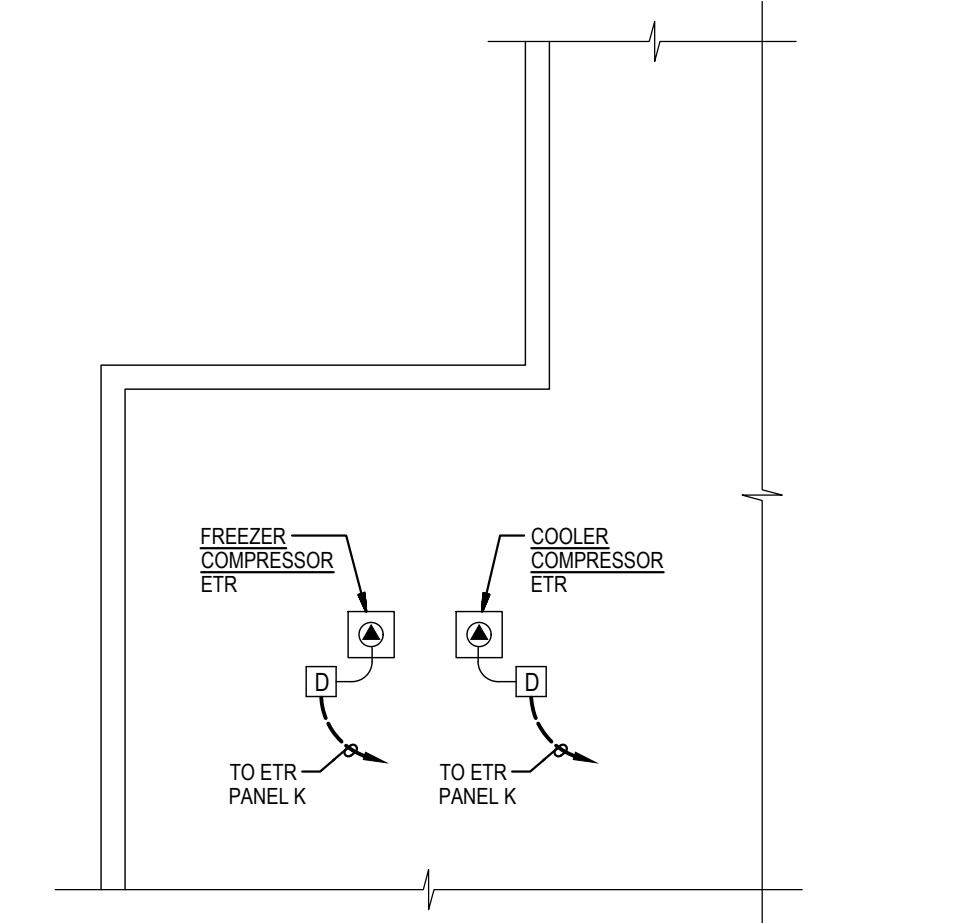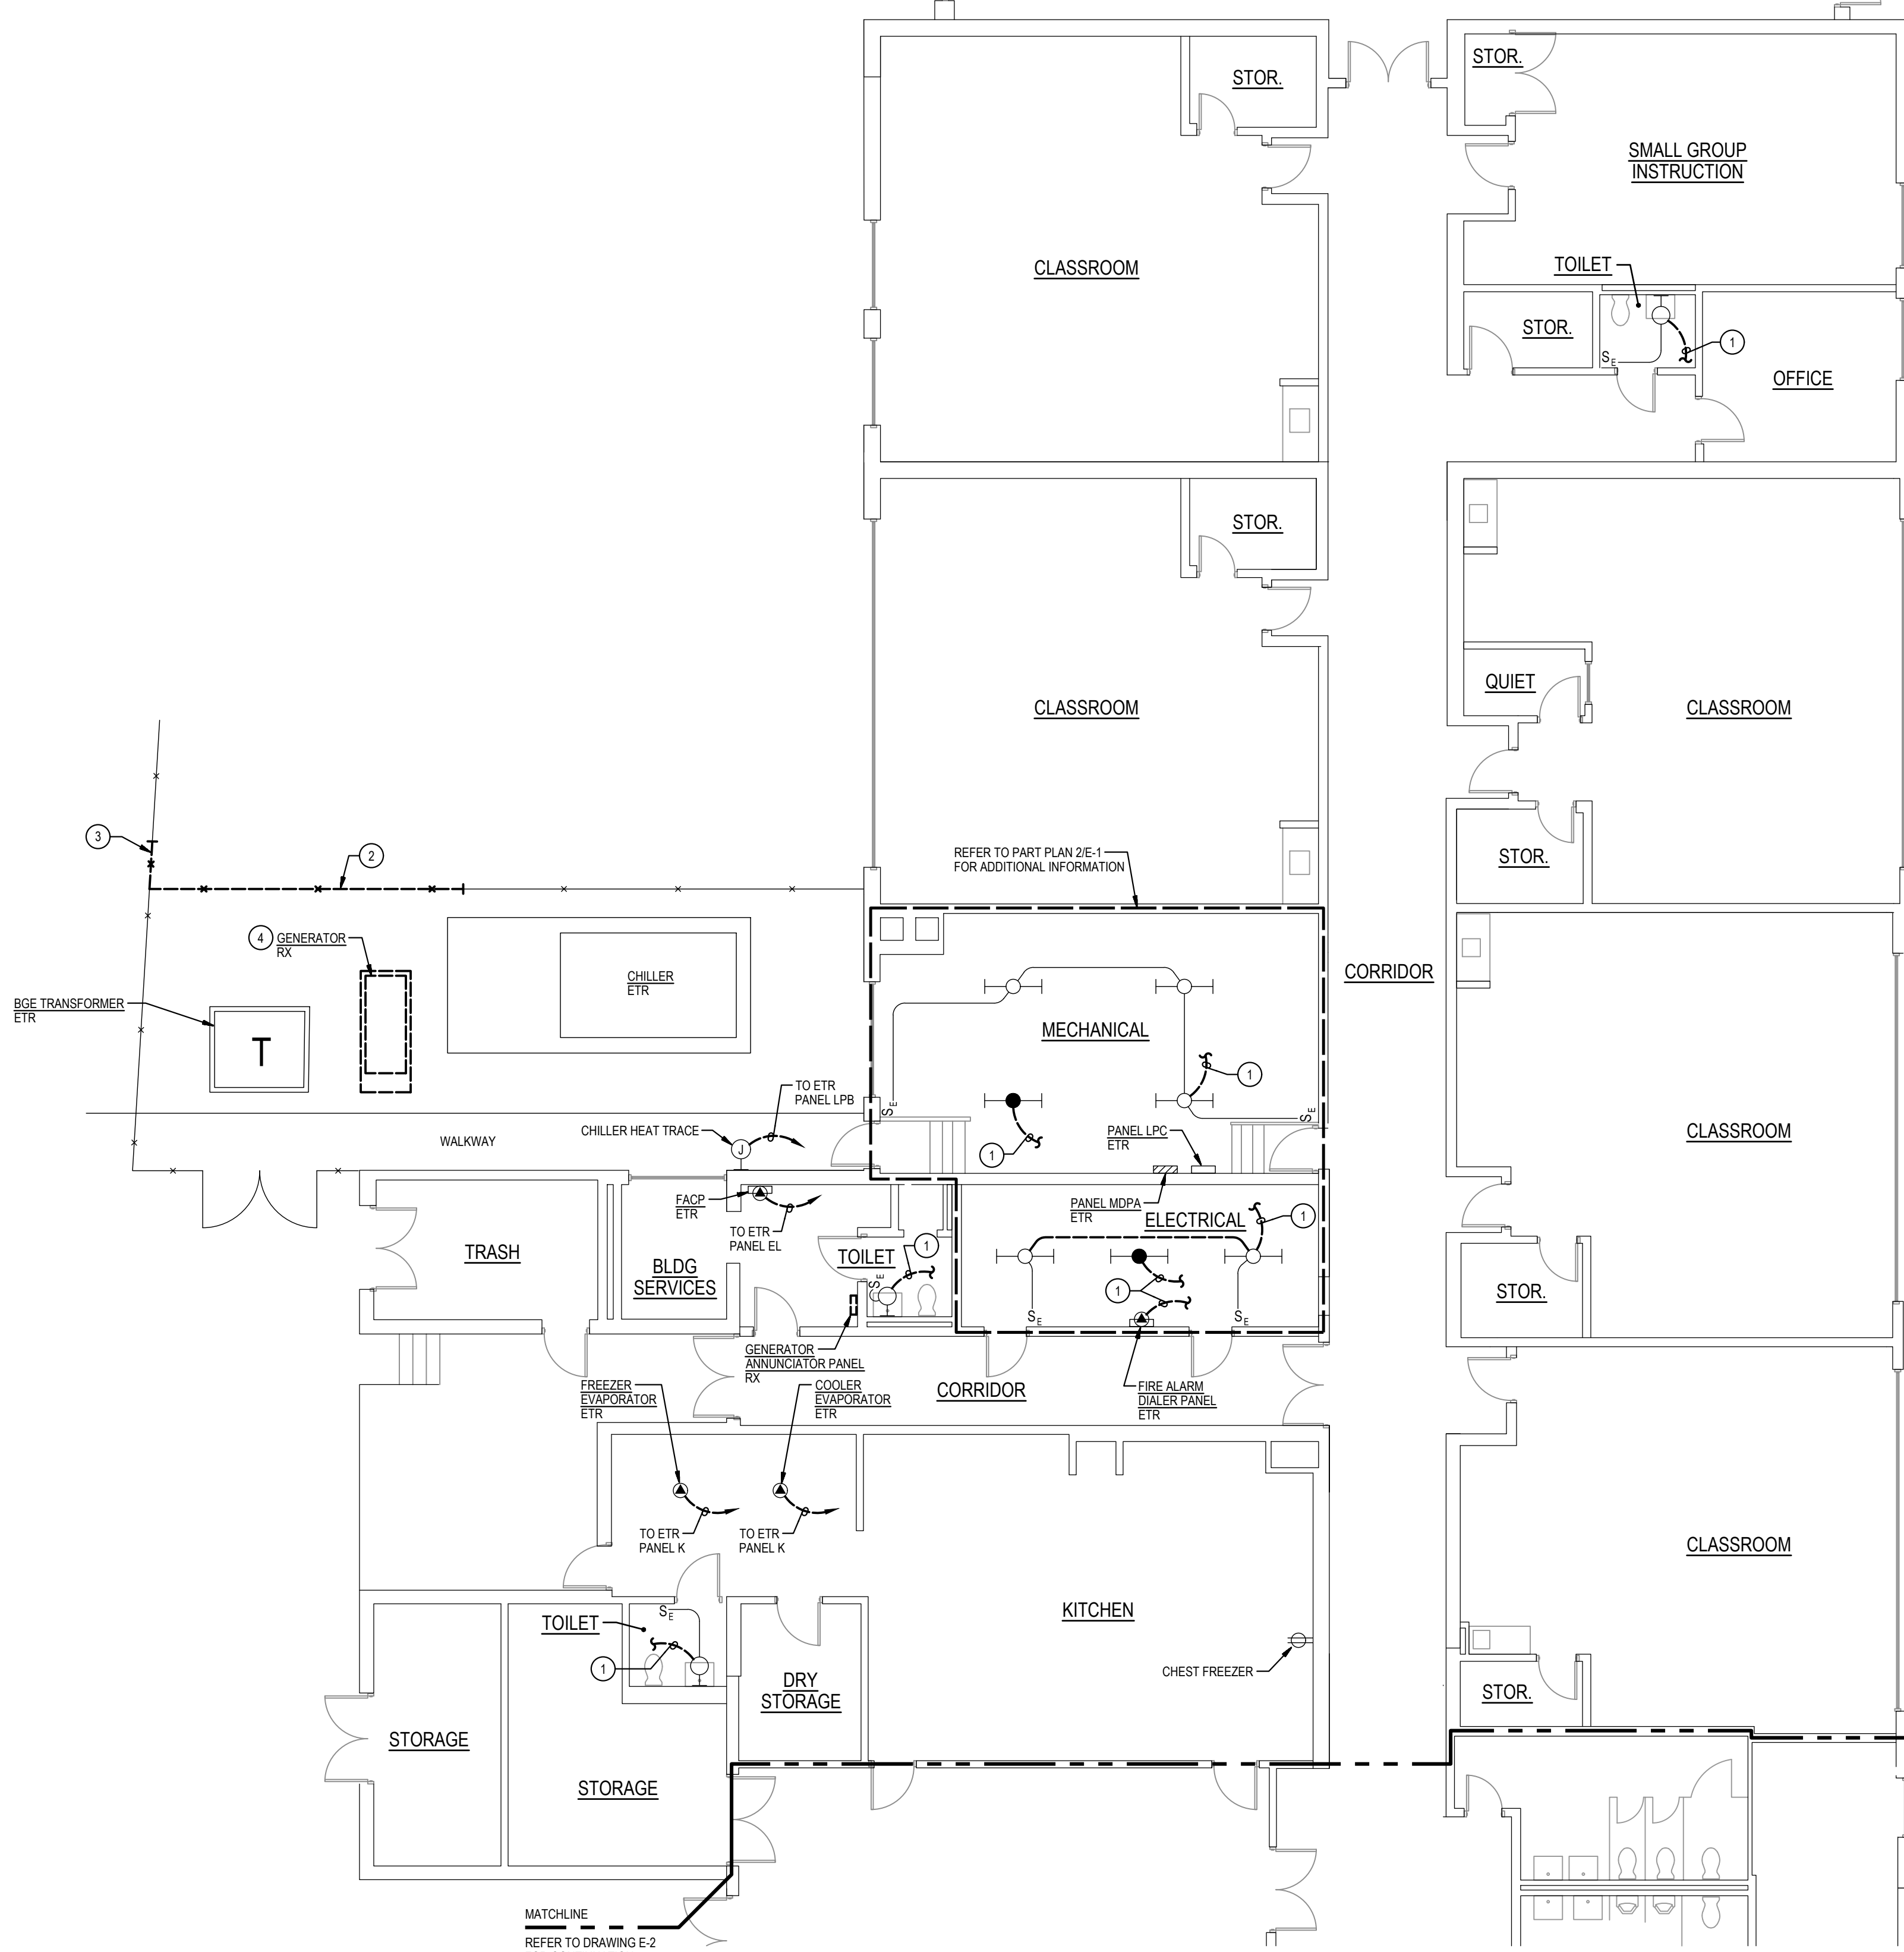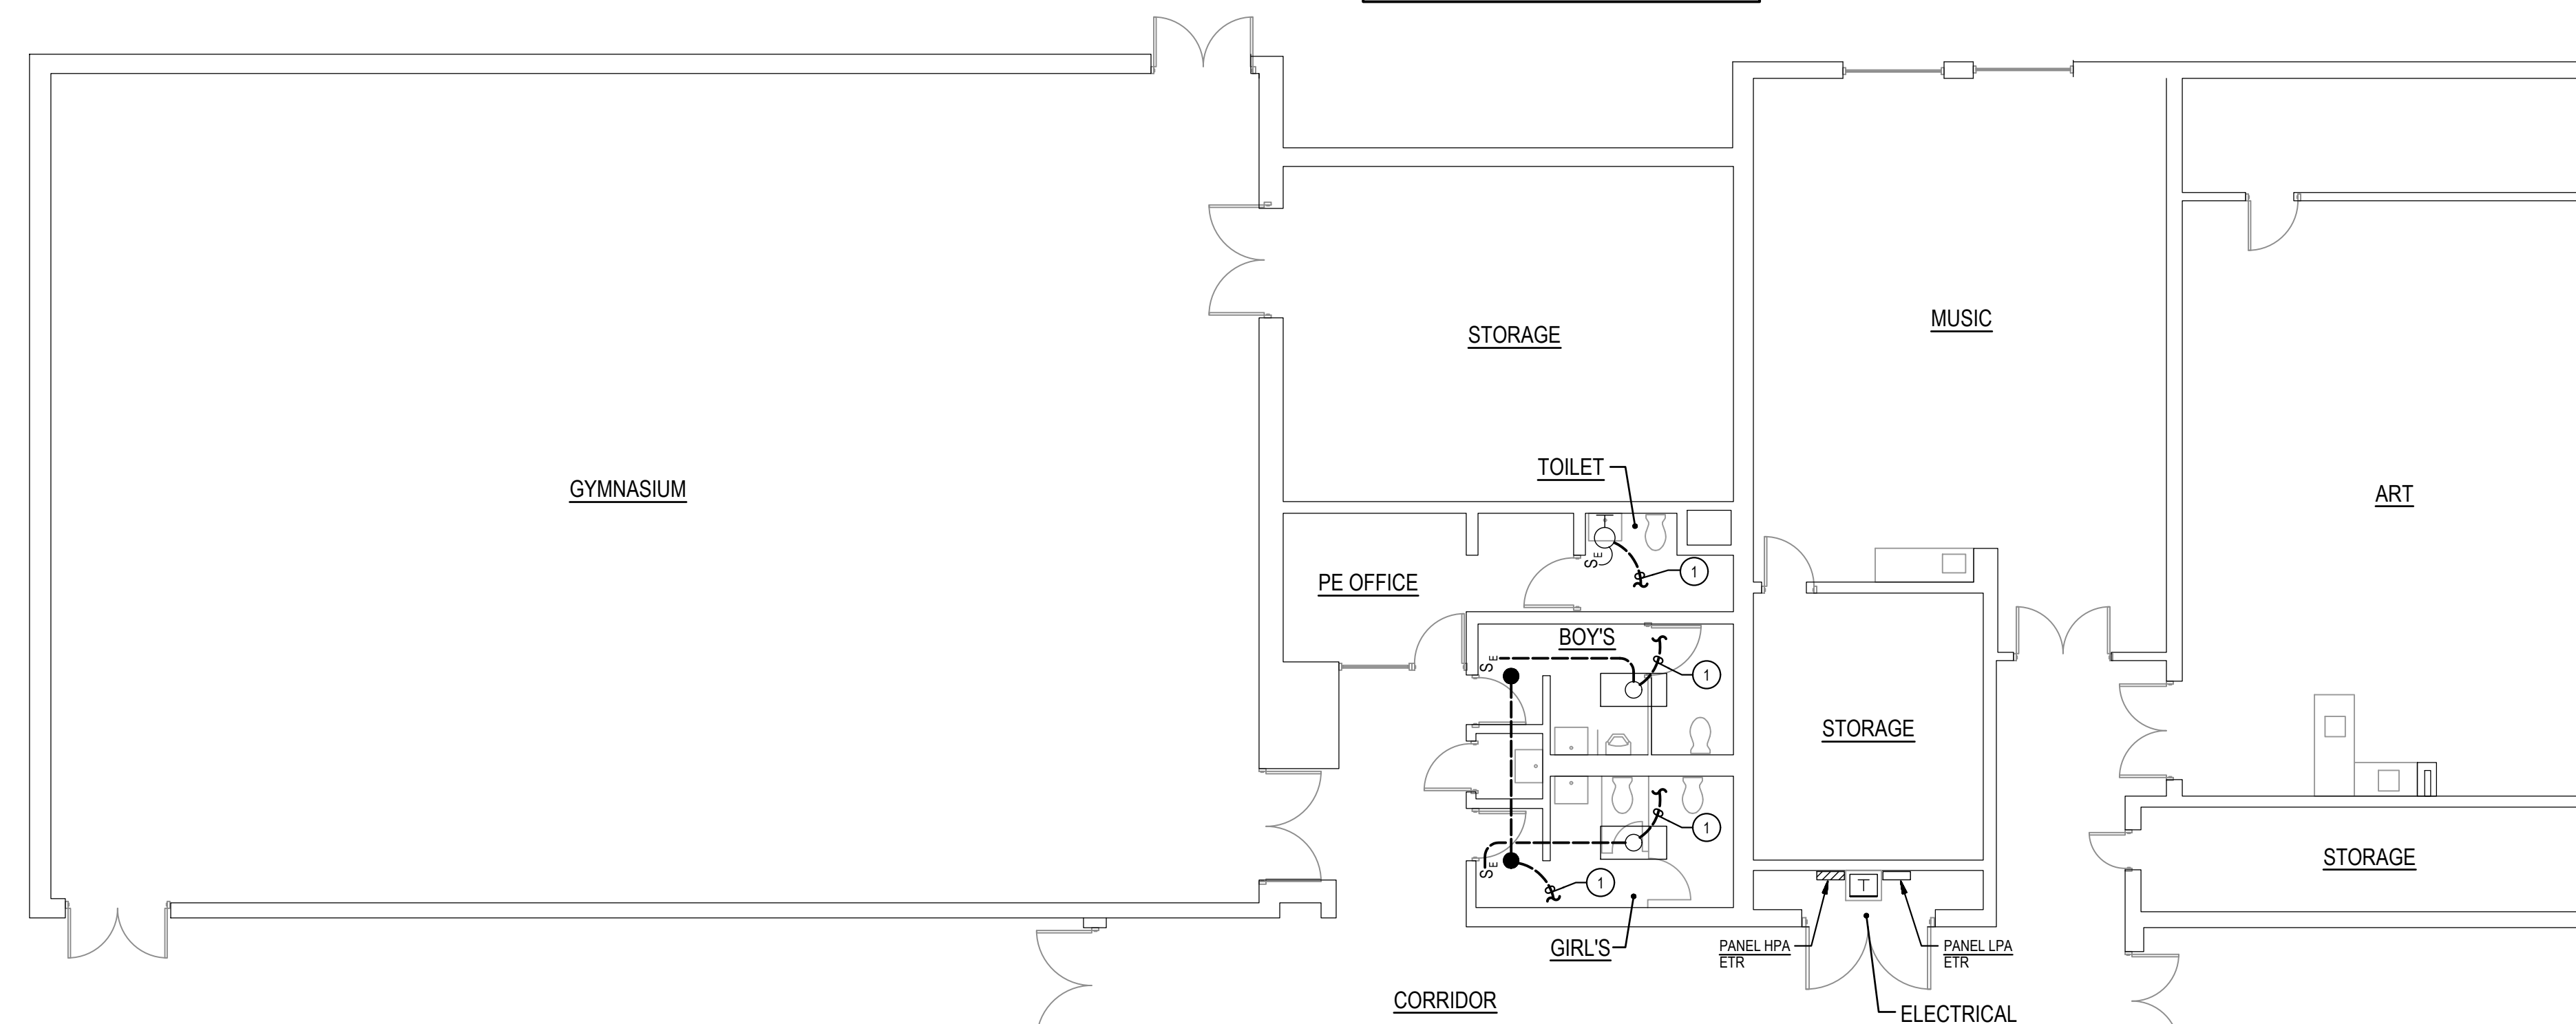

3 PART PLAN - ROOF DEMOLITION  
E-1 SCALE: 1/16" = 1'-0" NORTH

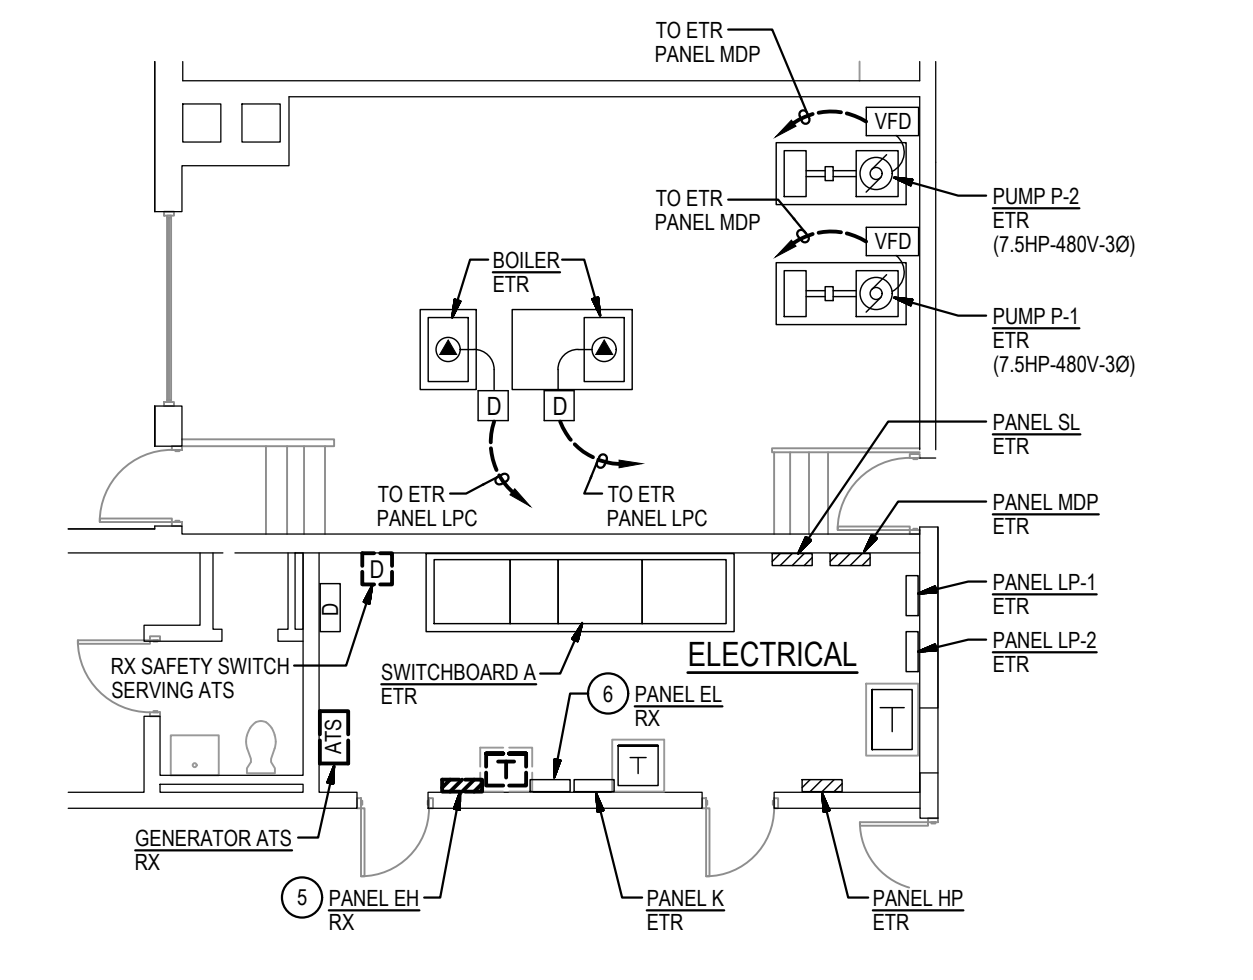

2 PART PLAN - ELECTRICAL ROOM DEMOLITION  
E-1 SCALE: 1/8" = 1'-0" NORTH

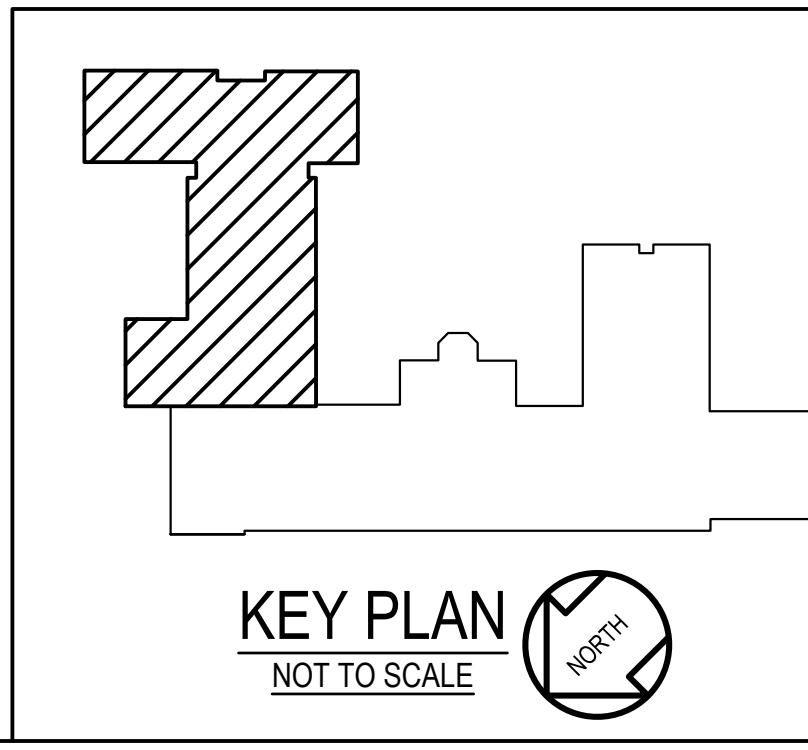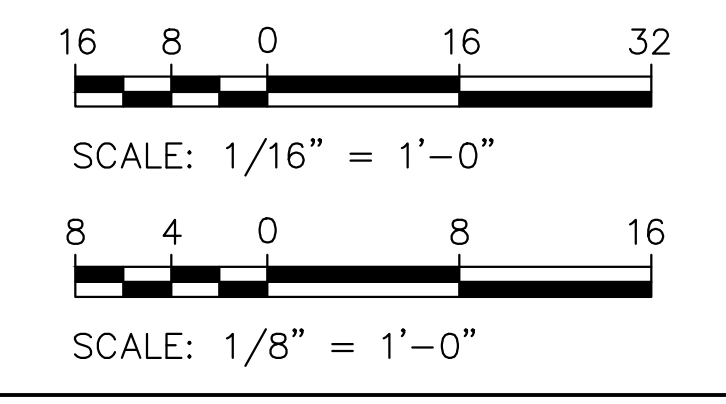

- GENERAL NOTES:**
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  - THE EXISTING FACILITY SHALL REMAIN IN OPERATION DURING RENOVATION. INTERRUPTION TO THE EXISTING BUILDING ELECTRIC SERVICE SHALL BE COORDINATED WITH THE OWNER TO MINIMIZE DISRUPTION. INTERRUPTION OF UTILITIES SHALL NOT OCCUR DURING SCHOOL WORKING HOURS.
  - REMOVE AND REINSTALL EXISTING CEILING TILES WITHIN CONSTRUCTION AREAS AS REQUIRED.
  - CONSTRUCTION SHALL BE PERFORMED IN PHASES. AVOID INTERRUPTION TO ANY SERVICES. GENERATOR POWER DISTRIBUTION SYSTEM SHALL BE OPERATIONAL AT ALL TIMES WHEN SCHOOL IS IN SESSION.
  - UNLESS OTHERWISE NOTED, ELECTRICAL ITEMS SHOWN HEAVY DASHED (---) SHALL BE REMOVED AND ELECTRICAL ITEMS SHOWN LIGHT SOLID (\_\_\_) SHALL REMAIN.
  - DEMOLITION SHALL INCLUDE REMOVAL AND OFF-SITE DISPOSAL OF MATERIALS. DO NOT ABANDON IN PLACE ANY ELECTRICAL COMPONENTS UNLESS OTHERWISE NOTED ON DRAWINGS.
  - WHERE EQUIPMENT IS NOTED "DISCONNECT" OR "REMOVE", REMOVE ASSOCIATED WIRE AND CONDUIT BACK TO SOURCE UNLESS OTHERWISE NOTED.
  - REMOVE EXISTING EQUIPMENT AND DEVICES INDICATED, INCLUDING ASSOCIATED WIRE AND CONDUIT BACK TO SOURCE UNLESS OTHERWISE NOTED.
  - EXISTING CIRCUITS INTERRUPTED BY DEMOLITION, BUT ARE TO REMAIN, SHALL BE MADE CONTINUOUS.
  - WHERE DEVICES ARE TO BE REMOVED AND REINSTALLED, PROVIDE WIRE AND CONDUIT TO NEW LOCATION AS REQUIRED.
  - IN BLOCK OR CONCRETE WALLS TO REMAIN, PROVIDE STAINLESS STEEL BLANK COVER PLATES FOR DEVICES REMOVED.
- SPECIFIC NOTES:**
- DISCONNECT AND REMOVE EXISTING WIRING IN CONDUIT SERVING EXISTING LIGHTING FIXTURES.
  - REMOVE PORTION OF CHAIN LINK FENCE TO ALLOW FOR INSTALLATION OF NEW WORK.
  - REMOVE PORTION OF WOOD FENCE TO ALLOW FOR INSTALLATION OF NEW WORK.
  - DISCONNECT AND REMOVE EXISTING GENERATOR, INCLUDING HOUSEKEEPING PAD AND CONDUIT AND WIRING BACK TO SOURCE FOR BLOCK HEATER, BATTERY CHARGER AND CONTROL WIRING.
  - REMOVE PORTION OF EXISTING BRANCH CIRCUITS EH7, EF-9, AND EH-11 TO ABOVE ACCESSIBLE CEILING SPACE FOR SPLICING TO NEW PANEL. REFER TO NEW WORK PLANS FOR ADDITIONAL INFORMATION.
  - DISCONNECT EXISTING BRANCH CIRCUITS FROM CIRCUIT BREAKERS. EXISTING CIRCUITS SHALL REMAIN. REMOVE INTERIOR COMPONENTS (BUSBAR, CIRCUIT BREAKERS) OF EXISTING PANEL EL. ENCLOSURE OF EXISTING PANEL EL SHALL REMAIN AND BECOME A PULLBOX.

GENERATOR AND ELECTRICAL EQUIPMENT REPLACEMENT  
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Tag	Description	Date
	BID SET	02/06/23


PSC No.	
Scale	AS NOTED
Project No.	7737-22
Date	FEBRUARY 6, 2023
Drawing Title	PART FLOOR PLAN AREA A DEMOLITION
Sheet No.	<b>E-1</b>

**GENERAL NOTES:**


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- B. THE EXISTING FACILITY SHALL REMAIN IN OPERATION DURING RENOVATION. INTERRUPTION TO THE EXISTING BUILDING ELECTRIC SERVICE SHALL BE COORDINATED WITH THE OWNER TO MINIMIZE DISRUPTION. INTERRUPTION OF UTILITIES SHALL NOT OCCUR DURING SCHOOL WORKING HOURS.
- C. REMOVE AND REINSTALL EXISTING CEILING TILES WITHIN CONSTRUCTION AREAS AS REQUIRED.
- D. CONSTRUCTION SHALL BE PERFORMED IN PHASES. AVOID INTERRUPTION TO ANY SERVICES. GENERATOR POWER DISTRIBUTION SYSTEM SHALL BE OPERATIONAL AT ALL TIMES WHEN SCHOOL IS IN SESSION.
- E. UNLESS OTHERWISE NOTED, ELECTRICAL ITEMS SHOWN HEAVY DASHED (---) SHALL BE REMOVED AND ELECTRICAL ITEMS SHOWN LIGHT SOLID (—) SHALL REMAIN.
- F. DEMOLITION SHALL INCLUDE REMOVAL AND OFF-SITE DISPOSAL OF MATERIALS. DO NOT ABANDON IN PLACE ANY ELECTRICAL COMPONENTS UNLESS OTHERWISE NOTED ON DRAWINGS.
- G. WHERE EQUIPMENT IS NOTED "DISCONNECT" OR "REMOVE", REMOVE ASSOCIATED WIRE AND CONDUIT BACK TO SOURCE, UNLESS OTHERWISE NOTED.
- H. REMOVE EXISTING EQUIPMENT AND DEVICES INDICATED, INCLUDING ASSOCIATED WIRE AND CONDUIT BACK TO SOURCE UNLESS OTHERWISE NOTED.
- I. EXISTING CIRCUITS INTERRUPTED BY DEMOLITION, BUT ARE TO REMAIN, SHALL BE MADE CONTINUOUS.
- J. WHERE DEVICES ARE TO BE REMOVED AND REINSTALLED, PROVIDE WIRE AND CONDUIT TO NEW LOCATION AS REQUIRED.
- K. IN BLOCK OR CONCRETE WALLS TO REMAIN, PROVIDE STAINLESS STEEL BLANK COVER PLATES FOR DEVICES REMOVED.

**SPECIFIC NOTES:**

- 1 DISCONNECT AND REMOVE EXISTING WIRING IN CONDUIT SERVING EXISTING LIGHTING FIXTURES AND FIRE ALARM EQUIPMENT, RESPECTIVELY.
- 2 DISCONNECT AND REMOVE EXISTING QUADRIPLEX (DOUBLE DUPLEX) RECEPTACLE, EXISTING OUTLET BOX, CONDUIT, AND WIRING TO REMAIN FOR REUSE. REFER TO NEW WORK DRAWINGS FOR ADDITIONAL INFORMATION.

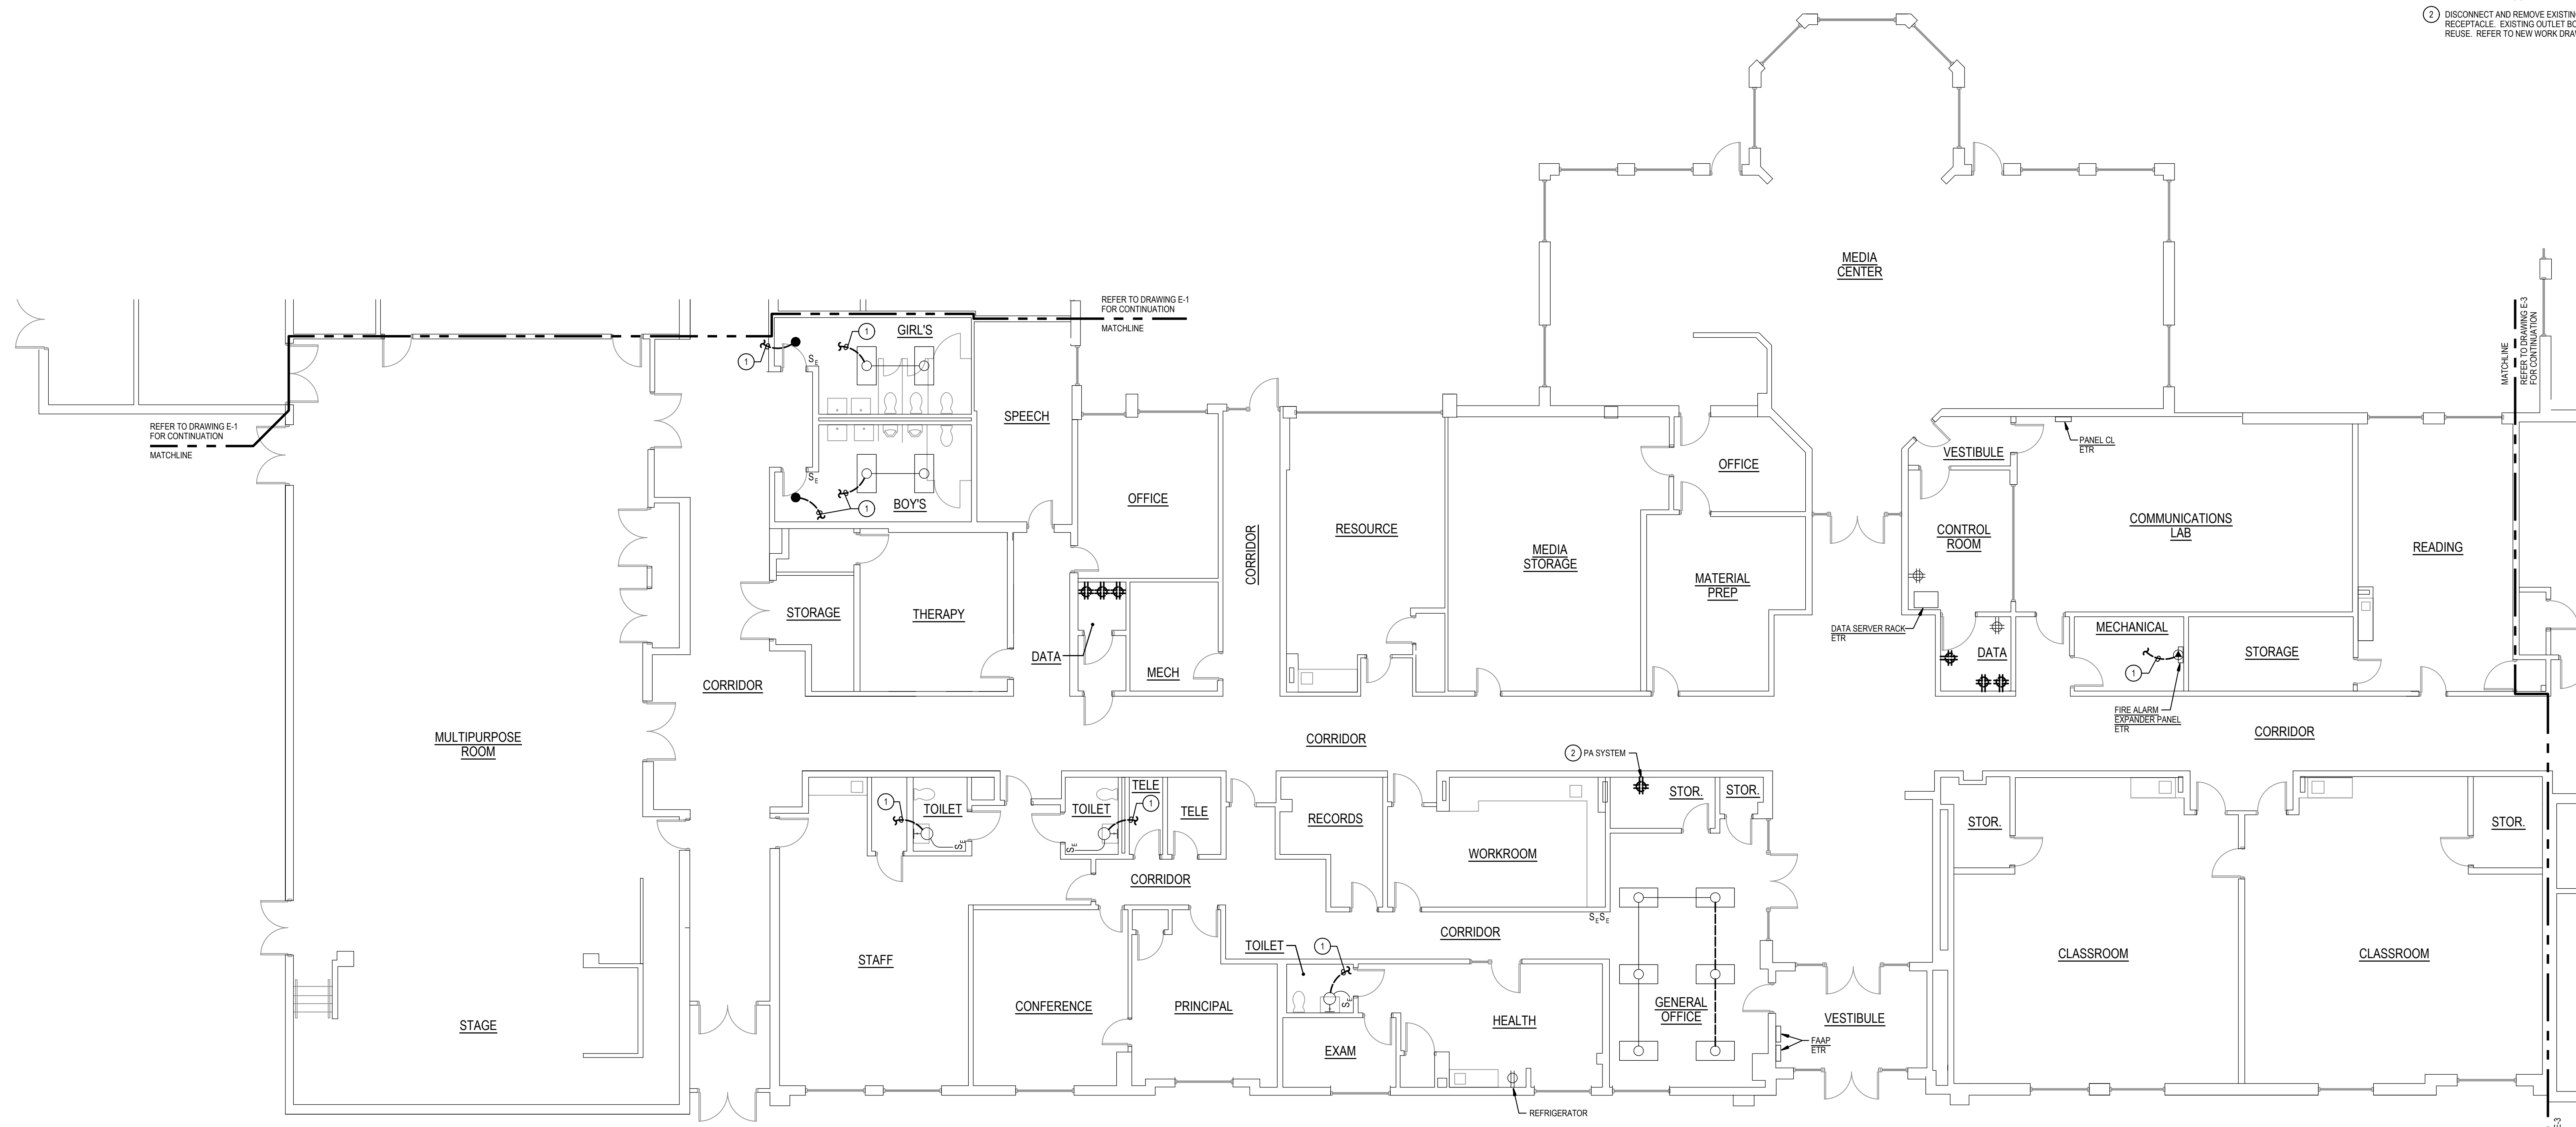

1  
E-2  
**PART FLOOR PLAN - AREA B**  
DEMOLITION  
SCALE: 1/8" = 1'-0"  
NORTH

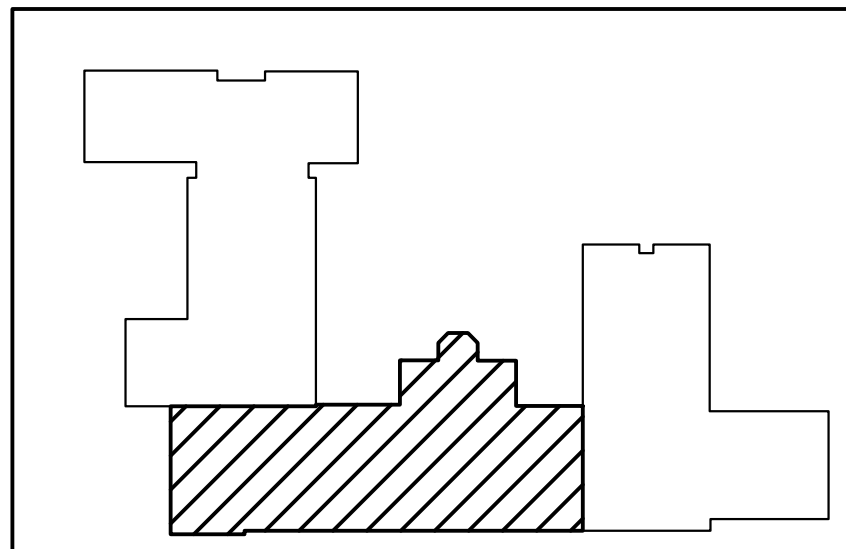

**KEY PLAN**  
NOT TO SCALE  
NORTH

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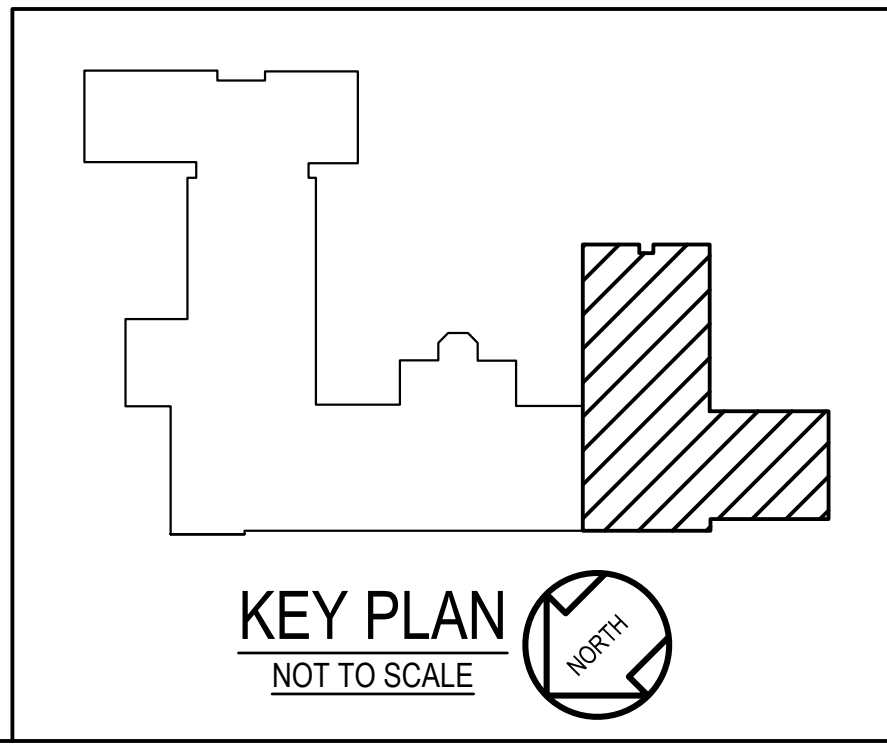
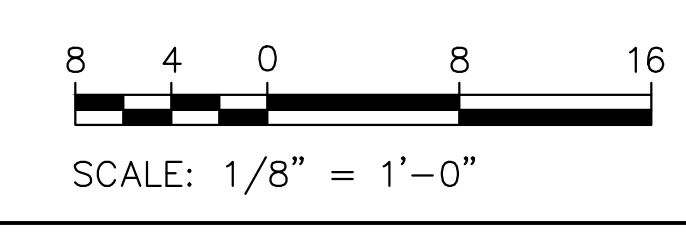
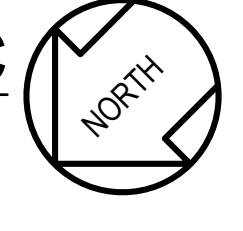
Drawing Title  
**PART FLOOR PLAN AREA B DEMOLITION**

Sheet No:  
**E-2**





1  
E-3  
PART FLOOR PLAN - AREA C  
DEMOLITION  
SCALE: 1/8" = 1'-0"



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  - C. REMOVE AND REINSTALL EXISTING CEILING TILES WITHIN CONSTRUCTION AREAS AS REQUIRED.
  - D. CONSTRUCTION SHALL BE PERFORMED IN PHASES. AVOID INTERRUPTION TO ANY SERVICES. GENERATOR POWER DISTRIBUTION SYSTEM SHALL BE OPERATIONAL AT ALL TIMES WHEN SCHOOL IS IN SESSION.
  - E. UNLESS OTHERWISE NOTED, ELECTRICAL ITEMS SHOWN HEAVY DASHED (---) SHALL BE REMOVED AND ELECTRICAL ITEMS SHOWN LIGHT SOLID (—) SHALL REMAIN.
  - F. DEMOLITION SHALL INCLUDE REMOVAL AND OFF-SITE DISPOSAL OF MATERIALS. DO NOT ABANDON IN PLACE ANY ELECTRICAL COMPONENTS UNLESS OTHERWISE NOTED ON DRAWINGS.
  - G. WHERE EQUIPMENT IS NOTED "DISCONNECT" OR "REMOVE", REMOVE ASSOCIATED WIRE AND CONDUIT BACK TO SOURCE UNLESS OTHERWISE NOTED.
  - H. REMOVE EXISTING EQUIPMENT AND DEVICES INDICATED, INCLUDING ASSOCIATED WIRE AND CONDUIT BACK TO SOURCE UNLESS OTHERWISE NOTED.
  - I. EXISTING CIRCUITS INTERRUPTED BY DEMOLITION, BUT ARE TO REMAIN, SHALL BE MADE CONTINUOUS.
  - J. WHERE DEVICES ARE TO BE REMOVED AND REINSTALLED, PROVIDE WIRE AND CONDUIT TO NEW LOCATION AS REQUIRED.
  - K. IN BLOCK OR CONCRETE WALLS TO REMAIN, PROVIDE STAINLESS STEEL BLANK COVER PLATES FOR DEVICES REMOVED.
- SPECIFIC NOTES:**
- 1 DISCONNECT AND REMOVE EXISTING CONDUIT AND WIRING SERVING EXISTING LIGHTING FIXTURE(S).
  - 2 DISCONNECT AND REMOVE EXISTING RECEPTACLE AND COVER PLATE, OUTLET BOX AND CONDUIT AND WIRING TO SUMP PUMP CONTROL PANEL. SHALL REMAIN FOR REUSE.

GENERATOR AND ELECTRICAL EQUIPMENT REPLACEMENT  
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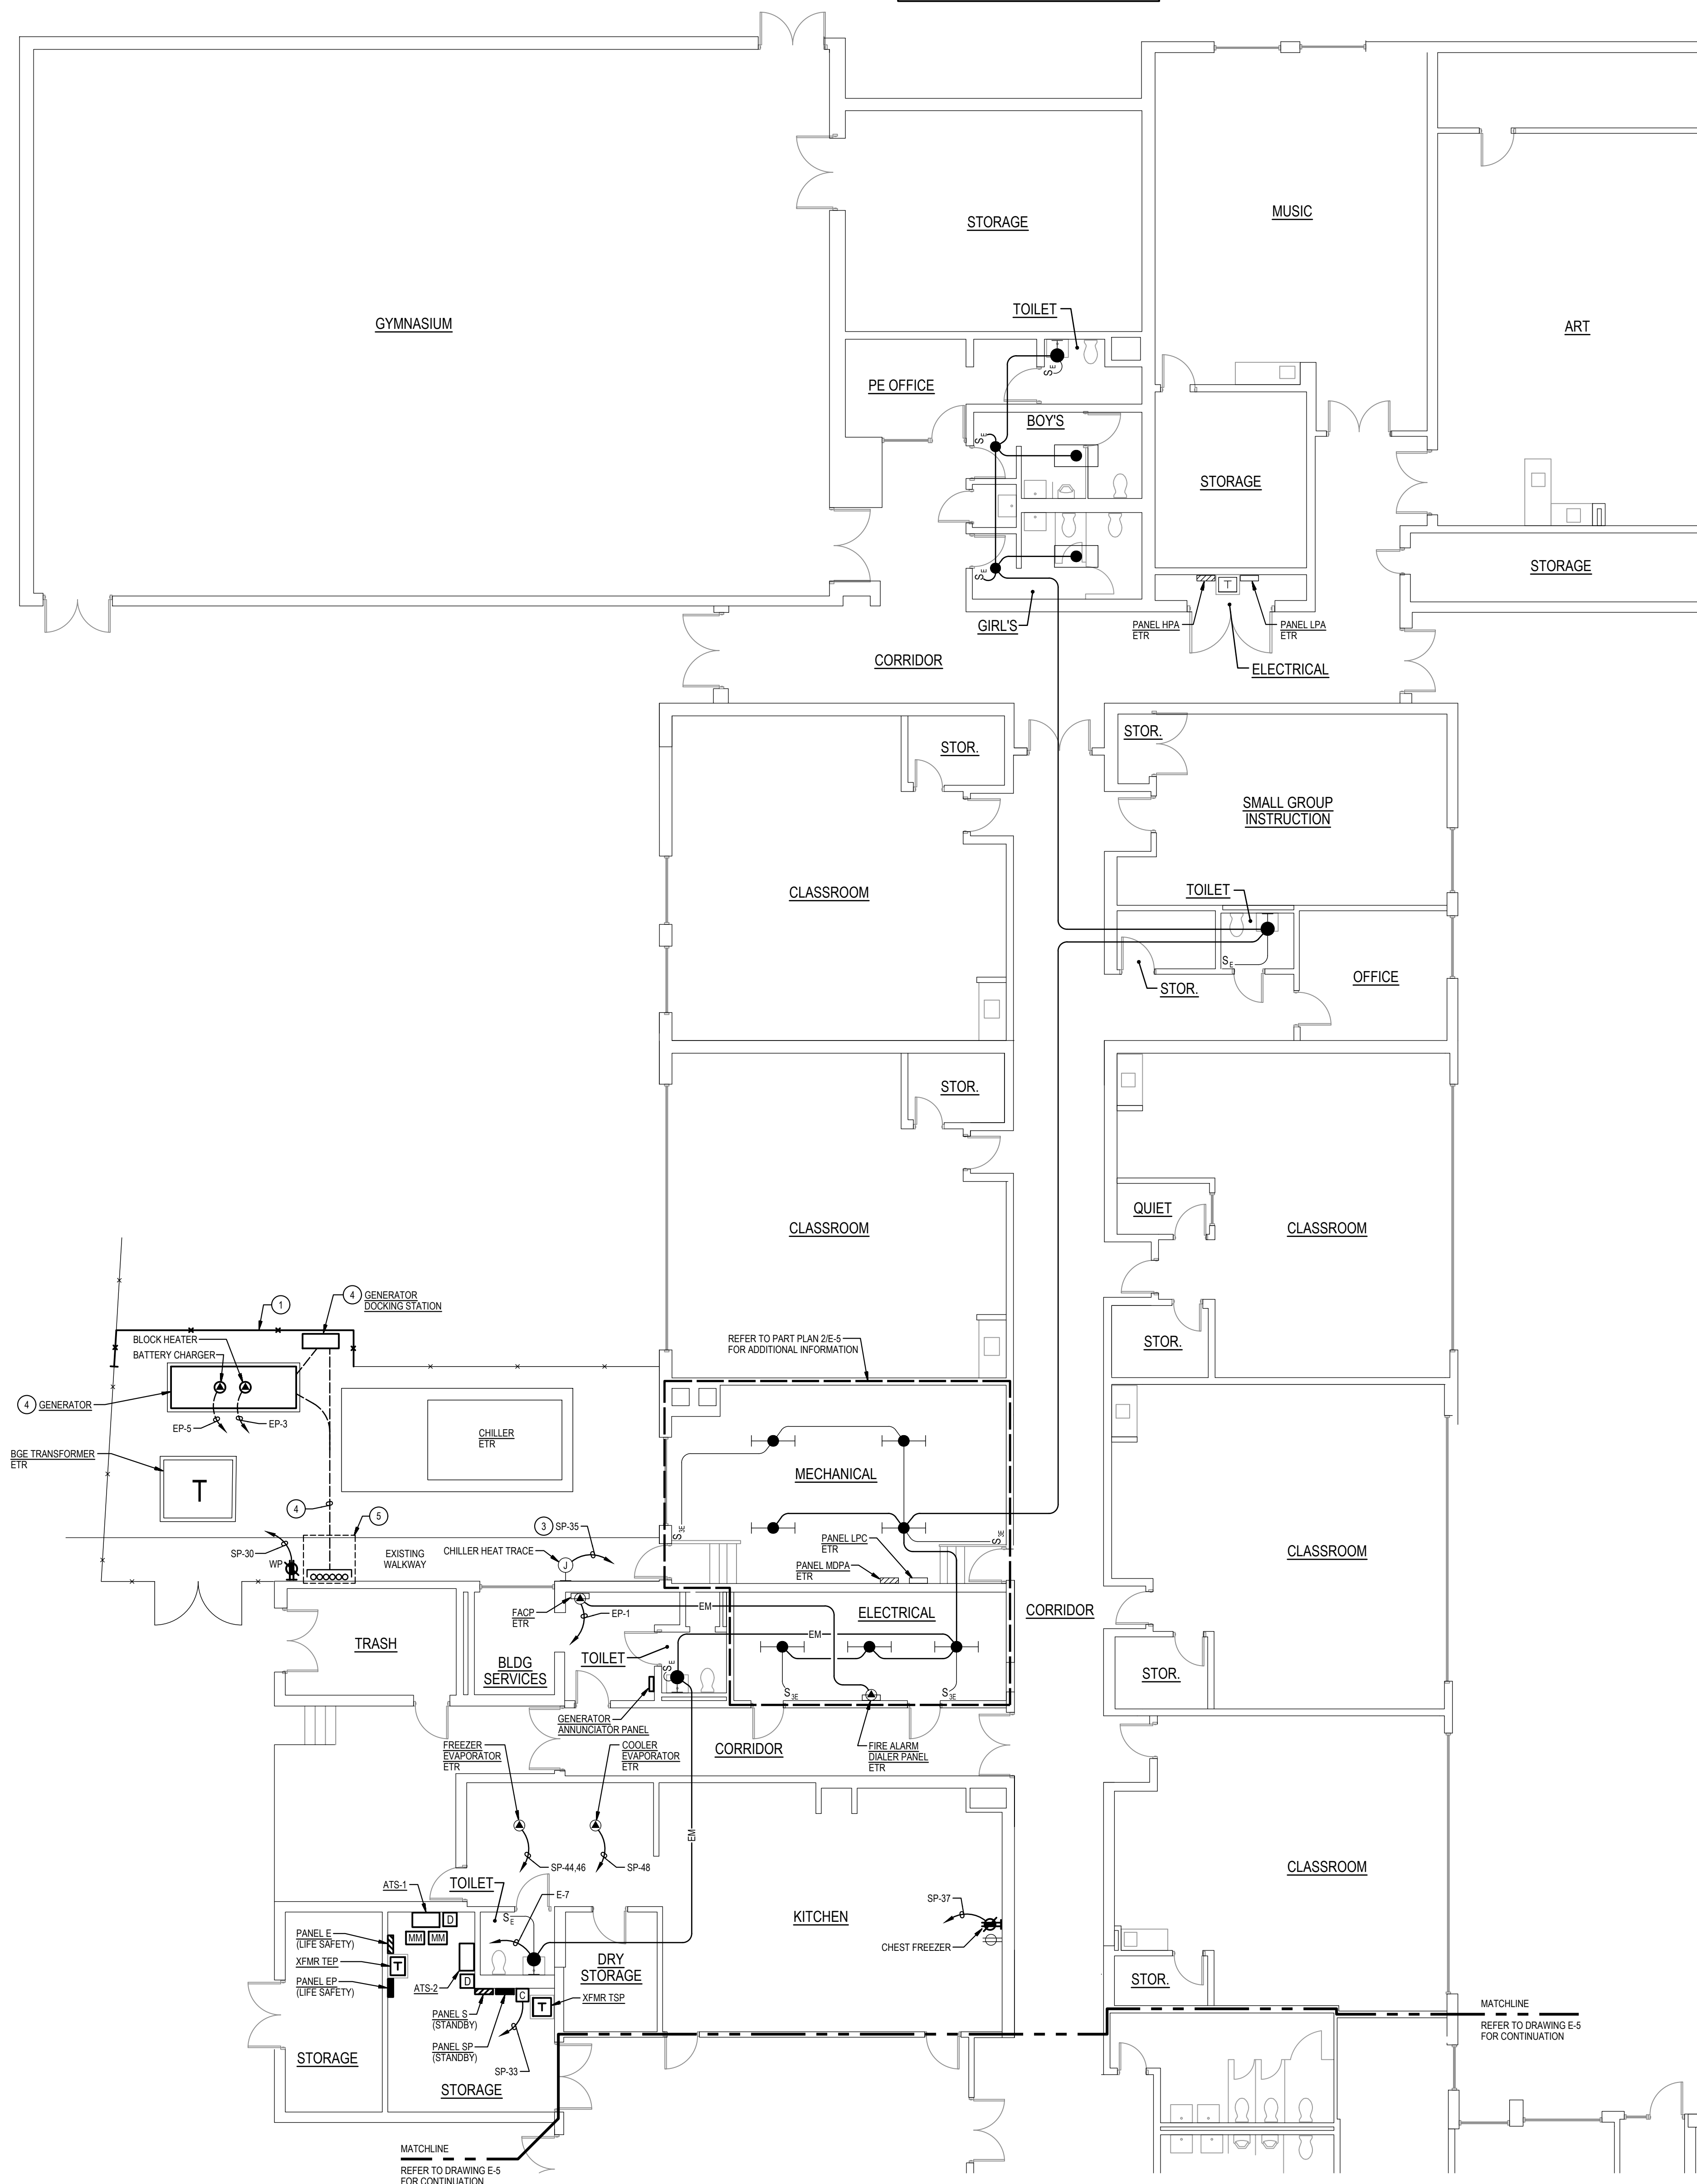
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PSC No.	
Scale	AS NOTED
Project No.	7737-22
Date	FEBRUARY 6, 2023
Drawing Title	PART FLOOR PLAN AREA C DEMOLITION
Sheet No.	<b>E-3</b>







1  
E-4  
PART FLOOR PLAN - AREA A  
NEW WORK  
SCALE: 1/8" = 1'-0"

3  
E-4  
PART PLAN - ROOF  
NEW WORK  
SCALE: 1/16" = 1'-0"



2  
E-4  
PART PLAN - ELECTRICAL ROOM AREA A  
NEW WORK  
SCALE: 1/8" = 1'-0"

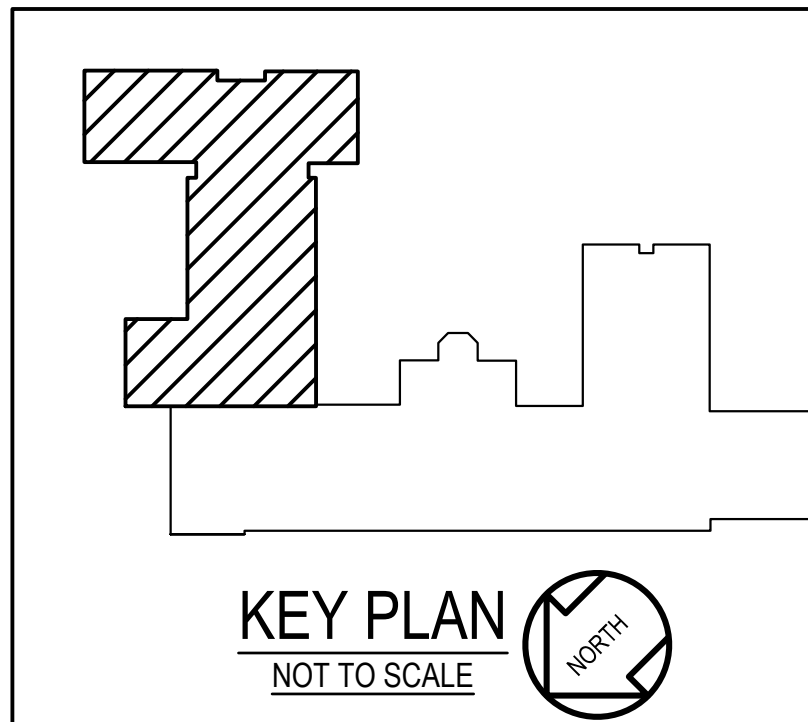

KEY PLAN  
NOT TO SCALE

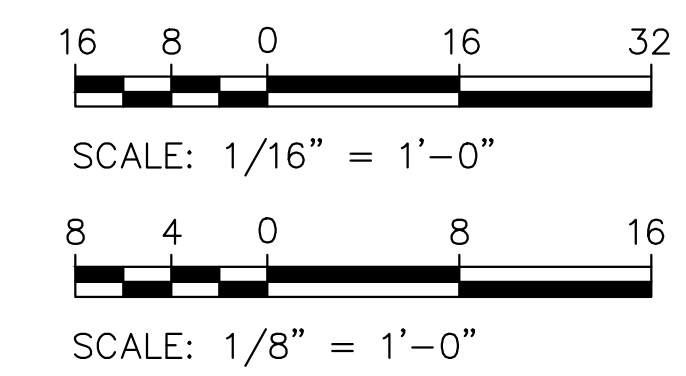

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  - REMOVE AND REINSTALL EXISTING CEILING TILES WITHIN CONSTRUCTION AREAS AS REQUIRED.
  - CONSTRUCTION SHALL BE PERFORMED IN PHASES. AVOID INTERRUPTION TO ANY SERVICES. GENERATOR POWER DISTRIBUTION SYSTEM SHALL BE OPERATIONAL AT ALL TIMES WHEN SCHOOL IS IN SESSION.
- SPECIFIC NOTES:**
- PROVIDE CHAIN LINK FENCE. MAINTAIN MINIMUM 3'-0" CLEARANCE AROUND GENERATOR.
  - SPlice EXISTING BRANCH CIRCUITS E-17, E-18, AND E-11 ABOVE ACCESSIBLE CEILING SPACE AND EXTEND TO PANEL E. REFER TO WIRING PANEL SCHEDULE E ON DRAWING E-7 FOR ADDITIONAL INFORMATION.
  - PROVIDE CONNECTION TO GFCI TYPE CIRCUIT BREAKER. REFER TO PANEL SCHEDULE E ON DRAWING E-7 FOR ADDITIONAL INFORMATION.
  - REFER TO POWER RISER DIAGRAM 26.7 FOR CONNECTIONS, DUCTBANK SIZES, AND ADDITIONAL INFORMATION ON ELECTRICAL EQUIPMENT AS NOTED.
  - CUT AND PATCH EXISTING CONCRETE WALKWAY AS NEEDED FOR INSTALLATION OF GENERATOR DUCTBANK AND CONDUITS.
  - UTILIZE PANELBOARD ENCLOSURE AS A PULLBOX TO INTERCEPT AND SPlice EXISTING BRANCH CIRCUITS E-2, 4, 6, 8, 10, 11, 12, 13, 14, 15, 16, 18, 20, 21, 22, 26, AND 28 AND EXTEND TO PANEL SP. REFER TO SPECIFIC NOTE 8 ON DRAWING E-1 AND WIRING SCHEDULE FOR PANEL SP ON DRAWING E-7 FOR ADDITIONAL INFORMATION.

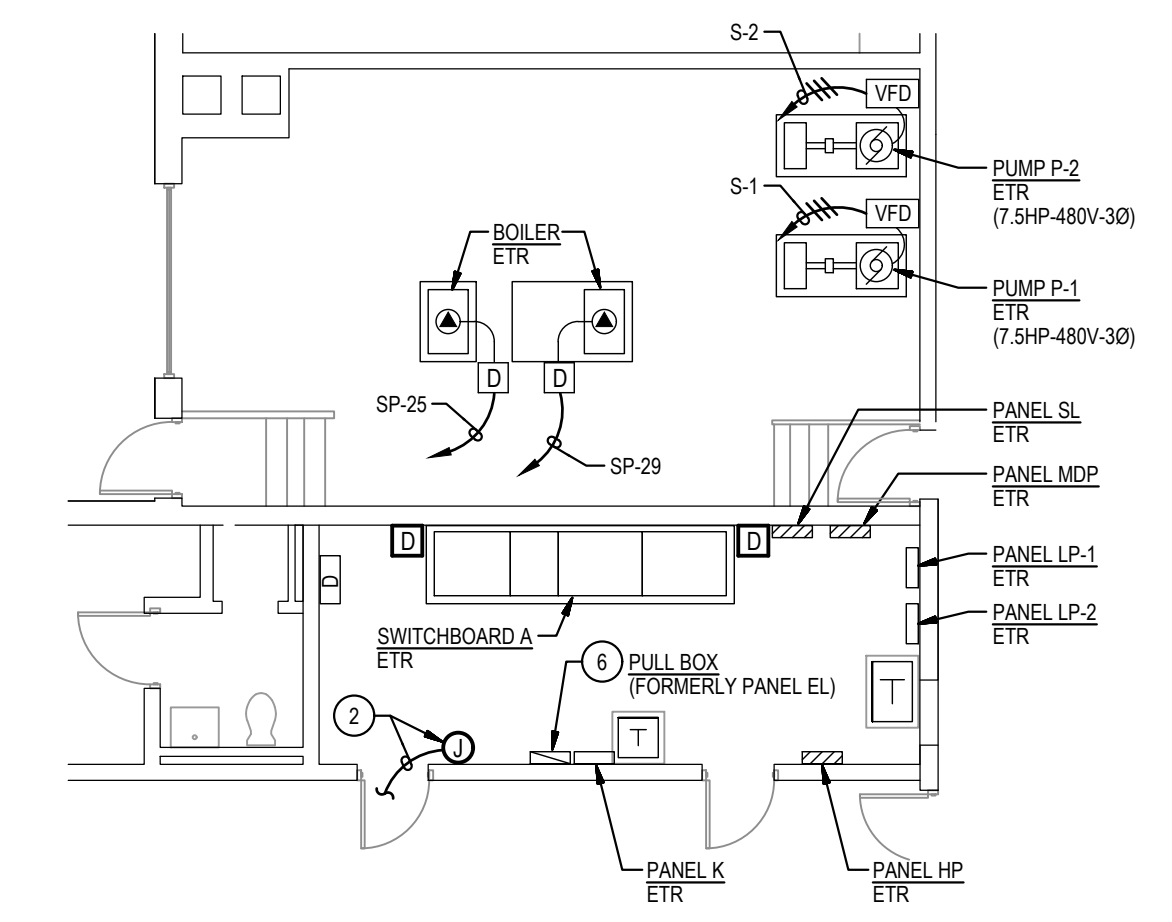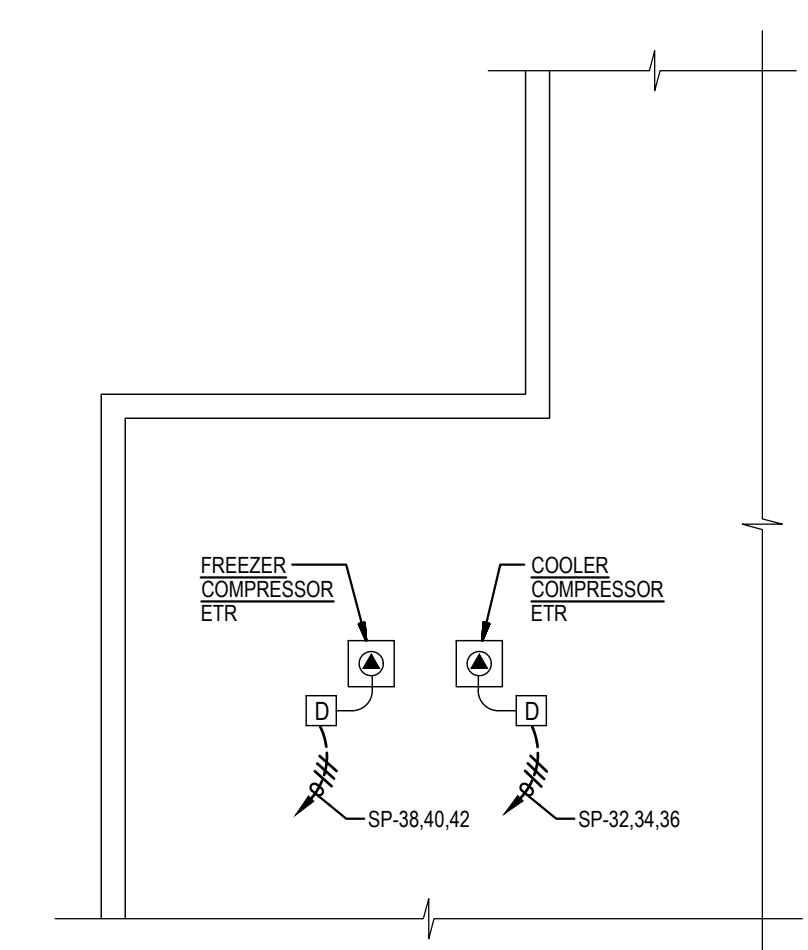

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PSC No.	
Scale	AS NOTED
Project No.	7737-22
Date	FEBRUARY 6, 2023
Drawing Title	PART FLOOR PLAN AREA A NEW WORK

Sheet No: **E-4**




**GENERAL NOTES:**



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- C. REMOVE AND REINSTALL EXISTING CEILING TILES WITHIN CONSTRUCTION AREAS AS REQUIRED.
- D. CONSTRUCTION SHALL BE PERFORMED IN PHASES. AVOID INTERRUPTION TO ANY SERVICES. GENERATOR POWER DISTRIBUTION SYSTEM SHALL BE OPERATIONAL AT ALL TIMES WHEN SCHOOL IS IN SESSION.

**SPECIFIC NOTES:**

- 1. PROVIDE QUADRI-PLEX RECEPTACLE IN EXISTING OUTLET BOX AND CONNECT TO EXISTING WIRING. PROVIDE NEW COVER PLATE.
- 2. PROVIDE CONNECTION TO GFCI TYPE CIRCUIT BREAKER. REFER TO PANEL SCHEDULE ON DRAWING E-7 FOR ADDITIONAL INFORMATION.

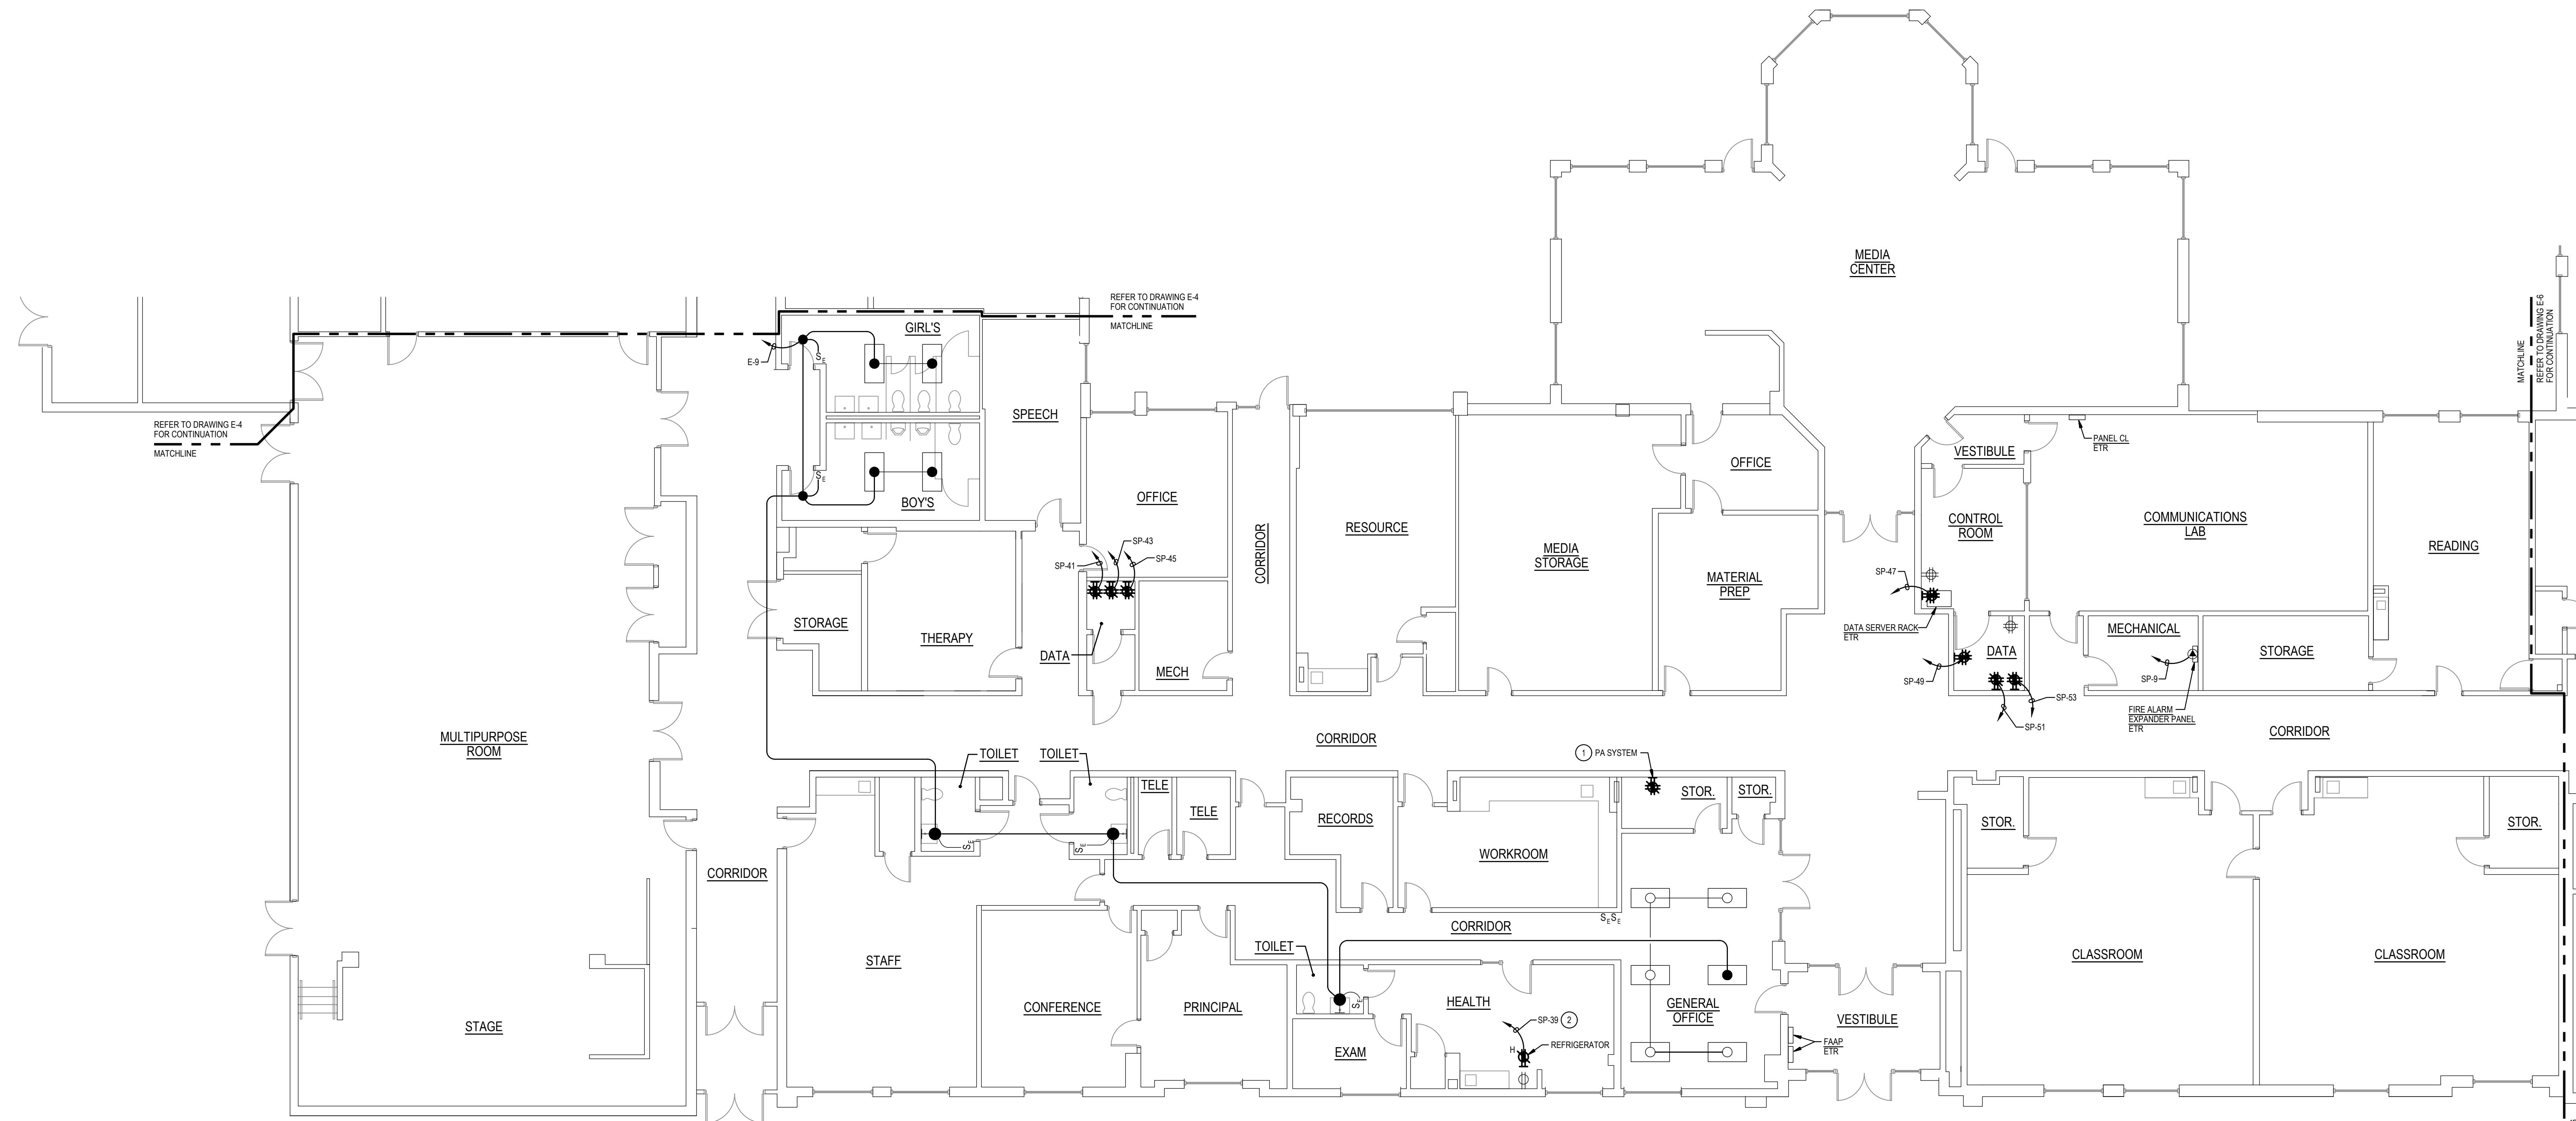

1  
E-5  
PART FLOOR PLAN - AREA B  
NEW WORK  
SCALE: 1/8" = 1'-0"

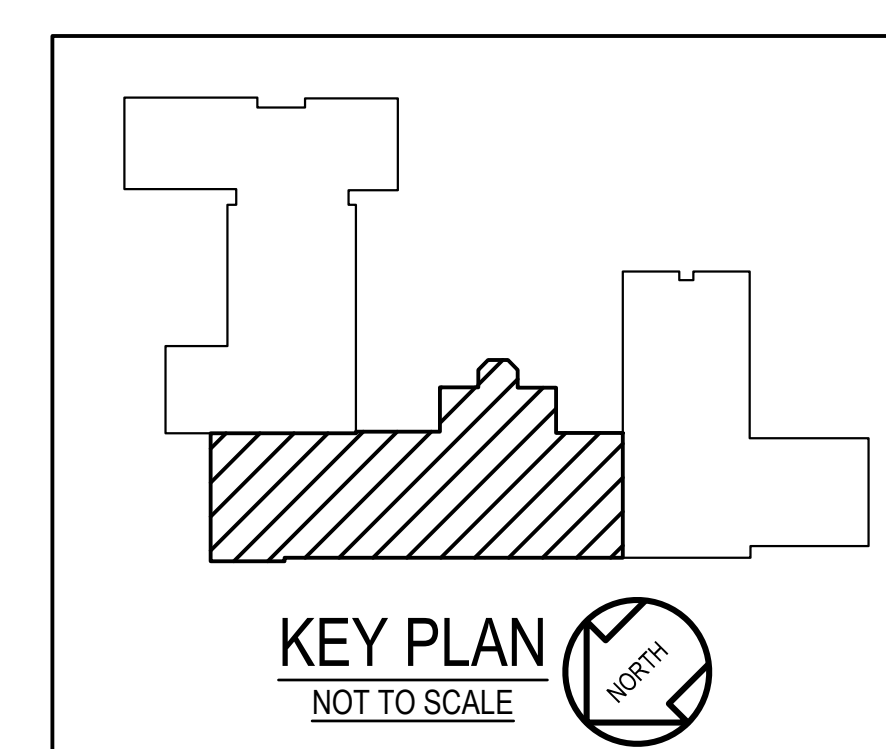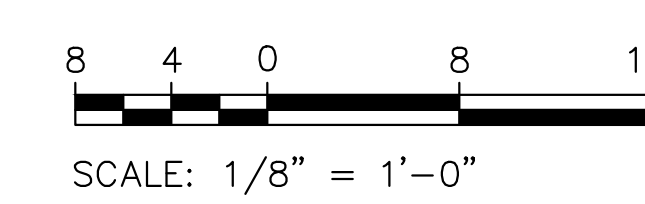

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PSC No.	
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Project No.	7737-22
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Drawing Title  
**PART FLOOR PLAN AREA B NEW WORK**

Sheet No:  
**E-5**








REFER TO DRAWINGS FOR CONTINUATION MATCHLINE

REFER TO DRAWINGS FOR CONTINUATION MATCHLINE

1  
E-6  
PART FLOOR PLAN - AREA C  
NEW WORK  
SCALE: 1/8" = 1'-0"

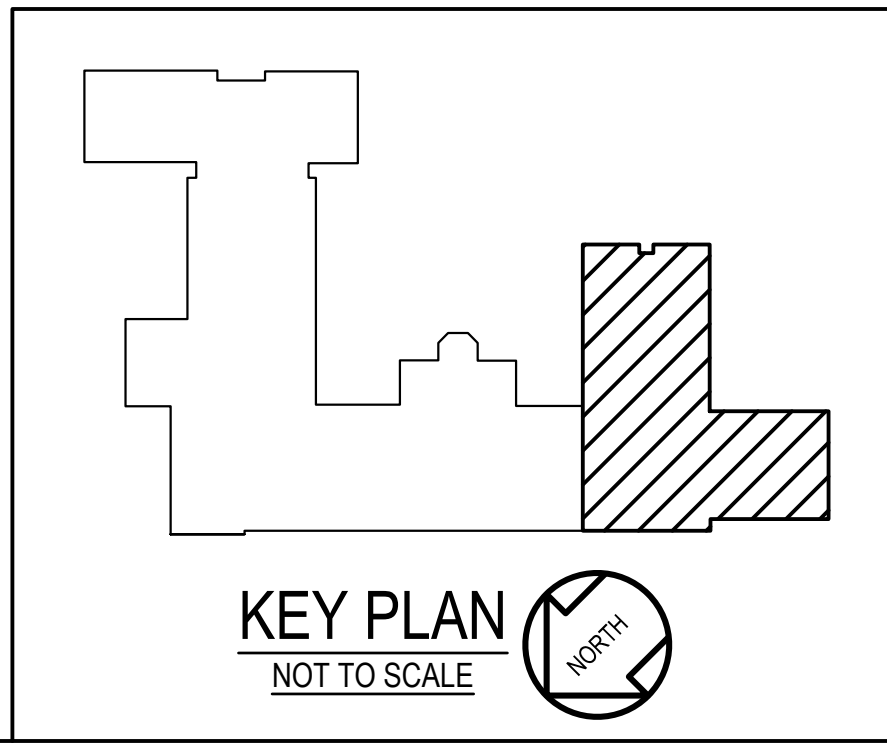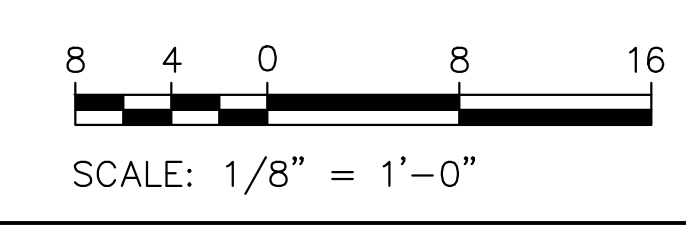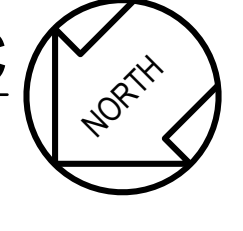

- GENERAL NOTES:**
- A. INFORMATION SHOWN ON THIS DRAWING PERTAINING TO EXISTING CONDITIONS HAS BEEN OBTAINED FROM AVAILABLE BUILDING DRAWINGS OR GENERAL FIELD OBSERVATIONS AND MAY NOT INDICATE EXISTING CONDITIONS IN DETAIL OR DIMENSION. DETERMINE EXISTING CONDITIONS PRIOR TO FABRICATION OR PERFORMANCE OF ANY WORK. SHOULD CONDITIONS BE DISCOVERED THAT PREVENT EXECUTION OF THE WORK AS INDICATED, IMMEDIATELY NOTIFY THE ENGINEER IN WRITING AND AWAIT DIRECTION BEFORE PROCEEDING WITH THE WORK.
  - B. THE EXISTING FACILITY SHALL REMAIN IN OPERATION DURING RENOVATION. INTERRUPTION TO THE EXISTING BUILDING ELECTRIC SERVICE SHALL BE COORDINATED WITH THE OWNER TO MINIMIZE DISRUPTION. INTERRUPTION OF UTILITIES SHALL NOT OCCUR DURING SCHOOL WORKING HOURS.
  - C. REMOVE AND REINSTALL EXISTING CEILING TILES WITHIN CONSTRUCTION AREAS AS REQUIRED.
  - D. CONSTRUCTION SHALL BE PERFORMED IN PHASES. AVOID INTERRUPTION TO ANY SERVICES. GENERATOR POWER DISTRIBUTION SYSTEM SHALL BE OPERATIONAL AT ALL TIMES WHEN SCHOOL IS IN SESSION.
- SPECIFIC NOTES:**
- 1 PROVIDE RECEPTACLE IN EXISTING SURFACE MOUNTED OUTLET BOX AND INTERCONNECT TO SUMP PUMP CONTROL PANEL.

GENERATOR AND ELECTRICAL EQUIPMENT REPLACEMENT

# CLARKSBURG ELEMENTARY SCHOOL

13530 REDGRAVE PLACE  
CLARKSBURG, MD 20871

MONTGOMERY COUNTY PUBLIC SCHOOLS



Professional Certification. I hereby certify that these documents were prepared or approved by me, and that I am a duly licensed professional engineer under the laws of the state of Maryland. License No. 24861, Expiration date 02-24-2024.

**James Posey Associates**  
Engineering Your Vision  
Mechanical & Electrical Consulting Engineers  
1155 Red Run Boulevard, Suite 310  
Baltimore, Maryland 21117  
tel 410-265-6100  
jamesposey.com


Tag	Description	Date
	BID SET	02/06/23

PSC No.	
Scale	AS NOTED
Project No.	7737-22
Date	FEBRUARY 6, 2023
Drawing Title	PART FLOOR PLAN AREA C NEW WORK
Sheet No.	E-6




- GENERAL NOTES:**
- INFORMATION SHOWN ON THIS DRAWING PERTAINING TO EXISTING CONDITIONS HAS BEEN OBTAINED FROM AVAILABLE BUILDING DRAWINGS OR GENERAL FIELD OBSERVATIONS AND MAY NOT INDICATE EXISTING CONDITIONS IN DETAIL OR DIMENSION. DETERMINE EXISTING CONDITIONS PRIOR TO FABRICATION OR PERFORMANCE OF ANY WORK. SHOULD CONDITIONS BE DISCOVERED THAT PREVENT EXECUTION OF THE WORK AS INDICATED, IMMEDIATELY NOTIFY THE ENGINEER IN WRITING AND AWAIT DIRECTION BEFORE PROCEEDING WITH THE WORK.
  - THE EXISTING FACILITY SHALL REMAIN IN OPERATION DURING RENOVATION. INTERRUPTION TO THE EXISTING BUILDING ELECTRICAL SERVICE SHALL BE COORDINATED WITH THE OWNER TO MINIMIZE DISRUPTION. INTERRUPTION OF UTILITIES SHALL NOT OCCUR DURING SCHOOL WORKING HOURS.
  - REMOVE AND REINSTALL EXISTING CEILING TILES WITHIN CONSTRUCTION AREAS AS REQUIRED.
  - CONSTRUCTION SHALL BE PERFORMED IN PHASES. AVOID INTERRUPTION TO ANY SERVICES. GENERATOR POWER DISTRIBUTION SYSTEM SHALL BE OPERATIONAL AT ALL TIMES WHEN SCHOOL IS IN SESSION.
  - UNLESS OTHERWISE NOTED, ELECTRICAL ITEMS SHOWN HEAVY DASHED SHALL BE REMOVED AND ELECTRICAL ITEMS SHOWN LIGHT SOLID SHALL REMAIN.
  - DEMOLITION SHALL INCLUDE REMOVAL AND OFF-SITE DISPOSAL OF MATERIALS. DO NOT ABANDON IN PLACE ANY ELECTRICAL COMPONENTS UNLESS OTHERWISE NOTED ON DRAWINGS.
  - WHERE EQUIPMENT IS NOTED "DISCONNECT" OR "REMOVE", REMOVE ASSOCIATED WIRE AND CONDUIT BACK TO SOURCE UNLESS OTHERWISE NOTED.
  - REMOVE EXISTING EQUIPMENT AND DEVICES INDICATED, INCLUDING ASSOCIATED WIRE AND CONDUIT BACK TO SOURCE UNLESS OTHERWISE NOTED.
  - EXISTING CIRCUITS INTERRUPTED BY DEMOLITION, BUT ARE TO REMAIN, SHALL BE MADE CONTINUOUS.

- SPECIFIC NOTES:**
- PROVIDE TYPE 10 GENERATOR PER NEMA 110. THE GENERATOR SHALL BE ABLE TO PROVIDE GENERATOR POWER TO THE SCHOOL WITHIN 10 SECONDS AFTER A UTILITY POWER OUTAGE.
  - PROVIDE GENERATOR CONCRETE PAD. REFER TO DETAIL 7E-0 FOR ADDITIONAL INFORMATION.
  - REFER TO DIAGRAM 3E-0 FOR GENERATOR GROUNDING.
  - PROVIDE GENERATOR CONTROL WIRING IN CONDUIT BETWEEN GENERATOR CONTROL PANEL AND ASSOCIATED AUTOMATIC TRANSFER SWITCHES. MAKE CONNECTIONS NECESSARY FOR COMPLETE INSTALLATION. GENERATOR CONTROL WIRING SHALL BE AS PER GENERATOR MANUFACTURER'S RECOMMENDATIONS.
  - PROVIDE WIRING IN CONDUIT FROM GENERATOR CONTROL PANEL TO GENERATOR REMOTE ALARM ANNUNCIATOR PANEL. WIRING SHALL BE AS PER GENERATOR MANUFACTURER'S RECOMMENDATIONS.
  - PROVIDE 3P-200A ELECTRONIC TRIP CIRCUIT BREAKER TO SERVE GENERATOR EMERGENCY LIFE SAFETY LOADS. MOUNT CIRCUIT BREAKER WITH GENERATOR ENCLOSURE AND MAKE CONNECTIONS. COORDINATE LOCATION OF CIRCUIT BREAKER WITH GENERATOR MANUFACTURER.
  - PROVIDE 3P-100A CIRCUIT BREAKER TO SERVE GENERATOR STANDBY LOADS. MOUNT CIRCUIT BREAKER WITH GENERATOR ENCLOSURE AND MAKE CONNECTIONS. COORDINATE LOCATION OF CIRCUIT BREAKER WITH GENERATOR MANUFACTURER.
  - PROVIDE 4P-80A 1P-GROUND IN 2" CONDUIT BETWEEN 3P-200A ELECTRONIC TRIP CIRCUIT BREAKER AT GENERATOR SERVING EMERGENCY (LIFE SAFETY) LOADS AND GENERATOR DOCKING STATION, SIZED FOR LOAD BANK CONNECTION.
  - PROVIDE 200A GENERATOR DOCKING STATION IN NEMA TYPE 3R ENCLOSURE. EQUAL TO TRISTAR D005-3 WITH 3P-50A CIRCUIT BREAKERS. MARK KEY INTERLOCKED FOR CONNECTIONS TO 5, 1 AND PORTABLE MOBILE GENERATOR. FEEDER FOR LOAD BANK CONNECTION SHALL BE SIZED FOR 200A. PROVIDE SIGN ON FRONT OF GENERATOR DOCKING STATION TO READ AS FOLLOWS "SERVING EMERGENCY TRANSFER SWITCH (ATS-1) IN ELECTRICAL ROOM 1202003, 3 PHASE, 4 WIRE".
  - PROVIDE 4 #8 + #10 GROUND IN 2" CONDUIT. REFER TO DETAIL 7E-0 FOR GENERATOR DUCTBANK.
  - PROVIDE 4 #2 + #8 GROUND IN 2" CONDUIT. REFER TO DETAIL 7E-0 FOR GENERATOR DUCTBANK.
  - PROVIDE 4P-50A AUTOMATIC TRANSFER SWITCH (ATS) TO SERVE EMERGENCY LIFE SAFETY LOADS. ATS SHALL HAVE A MINIMUM UL 1008 WITHSTAND AND CLOSING RATING OF 65k AC. PROVIDE NAMEPLATE ON FRONT OF ATS TO READ "EMERGENCY ATS".
  - PROVIDE 4P-100A AUTOMATIC TRANSFER SWITCH (ATS) TO SERVE STANDBY LOADS. ATS SHALL HAVE A MINIMUM UL 1008 WITHSTAND AND CLOSING RATING OF 65k AC. PROVIDE NAMEPLATE ON FRONT OF ATS TO READ "STANDBY ATS".
  - PROVIDE 3P-600A 600V NON-FUSED ENCLOSED SWITCH WITH NEUTRAL KIT IN NEMA TYPE 1 ENCLOSURE TO SERVE GENERATOR EMERGENCY / LIFE SAFETY LOADS.
  - PROVIDE 3P-100A 600V NON-FUSED ENCLOSED SWITCH WITH NEUTRAL KIT IN NEMA TYPE 1 ENCLOSURE TO SERVE GENERATOR STANDBY LOADS.
  - PROVIDE 3P-600A 600V FUSED ENCLOSED SWITCH WITH NEUTRAL IN NEMA TYPE 1 ENCLOSURE. PROVIDE WITH 50A CURRENT-LIMITING FUSES.
  - PROVIDE 3P-100A 600V FUSED ENCLOSED SWITCH WITH NEUTRAL IN NEMA TYPE 1 ENCLOSURE. PROVIDE WITH 100A CURRENT-LIMITING FUSES.
  - PROVIDE LUGS ON BUS OF EXISTING SWITCHBOARD AND TAP BUS FOR CONNECTION TO FEEDER. PROVIDE UL CERTIFICATION (OR CERTIFICATION BY A NATIONALLY RECOGNIZED TESTING LABORATORY) FOR THE BUS TAP.
  - REFER TO SPECIFIC NOTE 6E-1 FOR ADDITIONAL INFORMATION.
  - REFER TO SPECIFIC NOTE 6E-4 FOR ADDITIONAL INFORMATION.

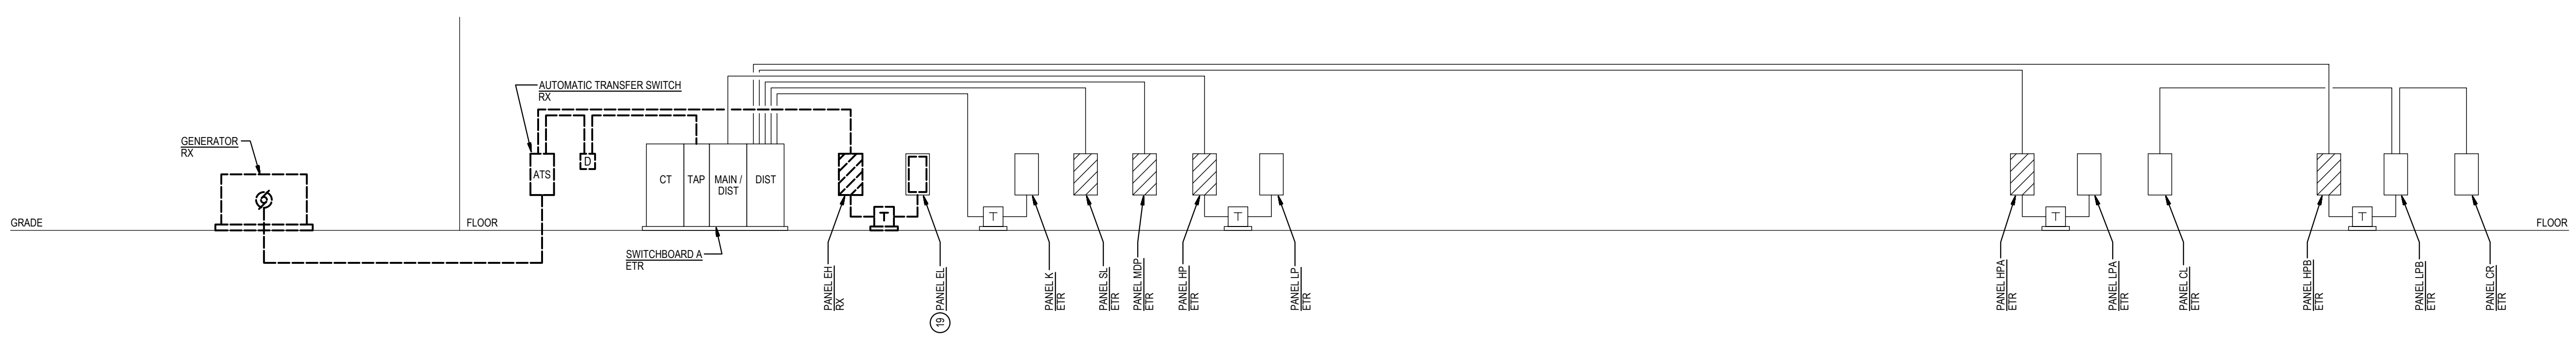

**1 POWER RISER DIAGRAM DEMOLITION**  
E-7  
NOT TO SCALE

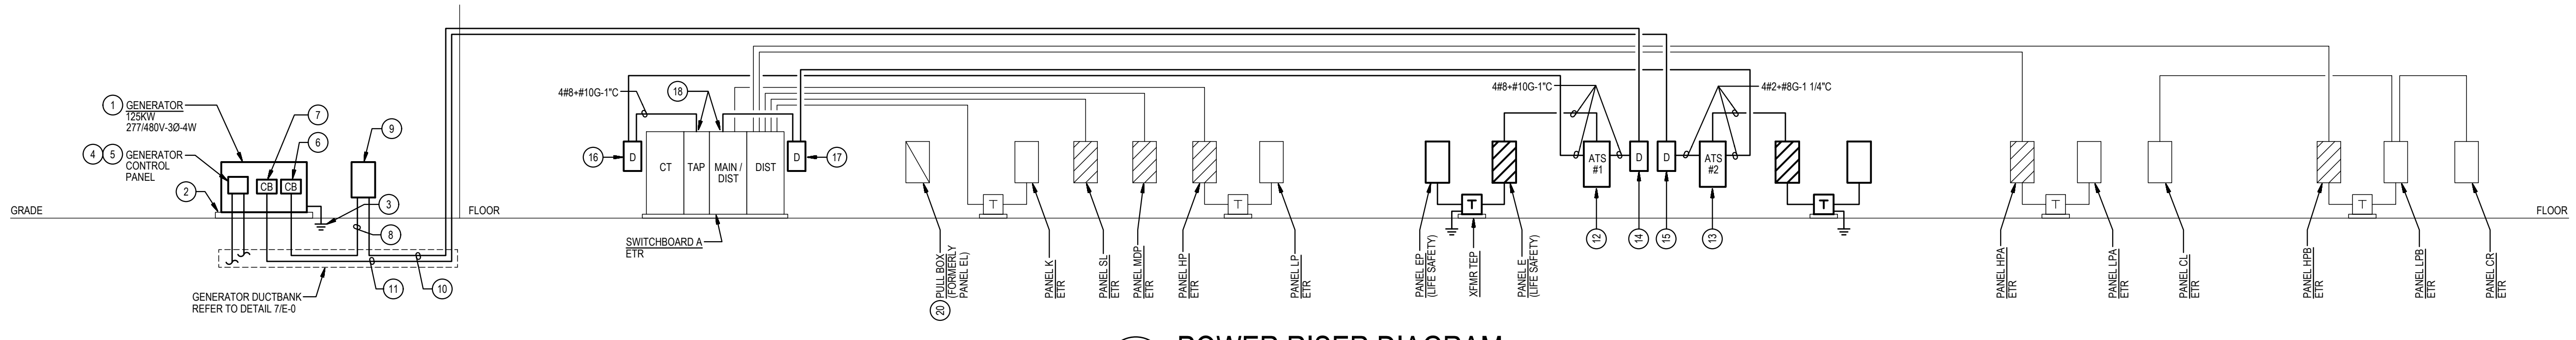

**2 POWER RISER DIAGRAM NEW WORK**  
E-7  
NOT TO SCALE

**WIRING SCHEDULE: PANEL E**

277 / 480 VOLTS			3 PHASE 4 WIRE			125 AMP BUS			SURFACE MOUNTED		
CR./POLE CUIT	DESCRIPTION	WIRE/CONDUIT	BREAKER POLE AMP	AØ	BØ	CØ	CR./POLE CUIT	DESCRIPTION	WIRE/CONDUIT	BREAKER POLE AMP	
1	1 CKT 1 LIGHTS (FROM EH-7)	#8-3/4" C	1 20	1.5			2	2 SPARE		1 20	
3	3 CKT 3 LIGHTS (FROM EH-9)	#8-3/4" C	1 20		1.5		4	4 SPARE		1 20	
5	5 CKT 5 LIGHTS (FROM EH-11)	#8-3/4" C	1 20			1.5	6	6 SPARE		1 20	
7	7 LTG AREA A	#8-3/4" C	1 20	1.3			8	8 SPARE		1 20	
9	9 LTG AREA B	#8-3/4" C	1 20		1.2		10	10 SPARE		1 20	
11	11 LTG AREA C	#8-3/4" C	1 20			0.8	12	12 SPARE		1 20	
-	13 SPACE AND PROVISIONS	-	-	-	-	-	-	14 SPACE AND PROVISIONS	-	-	
-	15 SPACE AND PROVISIONS	-	-	-	-	-	-	16 SPACE AND PROVISIONS	-	-	
-	17 SPACE AND PROVISIONS	-	-	-	-	-	-	18 SPACE AND PROVISIONS	-	-	
-	19 SPACE AND PROVISIONS	-	-	-	-	-	-	20 SPACE AND PROVISIONS	-	-	
-	21 SPACE AND PROVISIONS	-	-	-	-	-	-	22 SPACE AND PROVISIONS	-	-	
-	23 SPACE AND PROVISIONS	-	-	-	-	-	-	24 SPACE AND PROVISIONS	-	-	
25	25 XFMR TSP	#12G-3/4"	3 25	1.0	-	-	26	SPACE AND PROVISIONS	-	-	
27	27 (SERVING PANEL EP)	#12G-3/4"	-	-	-	0.5	28	SPACE AND PROVISIONS	-	-	
29	-	3/4"	-	-	-	0.5	30	SPACE AND PROVISIONS	-	-	
CONNECTED LOAD =				10.3	3.8	3.7	2.8	MAIN FUSE 50 AMPS			
DEMAND LOAD =				10.3							
MIN AC RATING =				42,000	AMPS SYMMETRICAL		LOCATION STORAGE				

NOTES:  
(1) PROVIDE FUSIBLE BRANCH CIRCUIT PANELBOARD.  
(2) PROVIDE PANELBOARD WITH INTEGRAL SURGE PROTECTION DEVICE.

**WIRING SCHEDULE: PANEL S**

277 / 480 VOLTS			3 PHASE 4 WIRE			125 AMP BUS			SURFACE MOUNTED		
CR./POLE CUIT	DESCRIPTION	WIRE/CONDUIT	BREAKER POLE AMP	AØ	BØ	CØ	CR./POLE CUIT	DESCRIPTION	WIRE/CONDUIT	BREAKER POLE AMP	
1	1 PUMP P-1	#10G-3/4"	3 25	2.9	2.9	2.9	2	2 PUMP P-2	#310+	3 25	
-	3	-	-	-	-	-	4	-	#10G-3/4"	1 20	
-	5	-	-	-	-	-	6	-	-	1 20	
7	7 SPARE	-	1 20	-	-	-	8	8 SPARE	-	1 20	
9	9 SPARE	-	1 20	-	-	-	10	10 SPARE	-	1 20	
11	11 SPARE	-	1 20	-	-	-	12	12 SPARE	-	1 20	
-	13 SPACE AND PROVISIONS	-	-	-	-	-	-	14 SPACE AND PROVISIONS	-	-	
-	15 SPACE AND PROVISIONS	-	-	-	-	-	-	16 SPACE AND PROVISIONS	-	-	
-	17 SPACE AND PROVISIONS	-	-	-	-	-	-	18 SPACE AND PROVISIONS	-	-	
-	19 SPACE AND PROVISIONS	-	-	-	-	-	-	20 SPACE AND PROVISIONS	-	-	
-	21 SPACE AND PROVISIONS	-	-	-	-	-	-	22 SPACE AND PROVISIONS	-	-	
-	23 SPACE AND PROVISIONS	-	-	-	-	-	-	24 SPACE AND PROVISIONS	-	-	
-	25 SPACE AND PROVISIONS	-	-	-	-	11.2	26	XFMR TSP	#3+	3 90	
-	27 SPACE AND PROVISIONS	-	-	-	-	9.1	28	(SERVING PANEL SP)	#8G-1 1/4"	1 20	
-	29 SPACE AND PROVISIONS	-	-	-	-	-	30	-	-	1 20	
CONNECTED LOAD =				49.6	2.9	2.9	14.8	MAIN BREAKER 100 AMPS			
DEMAND LOAD =				49.6	17.0	14.9	17.7				
MIN AC RATING =				65,000	AMPS SYMMETRICAL		LOCATION STORAGE				

**WIRING SCHEDULE: PANEL EP**

120 / 208 VOLTS			3 PHASE 4 WIRE			100 AMP BUS			SURFACE MOUNTED		
CR./POLE CUIT	DESCRIPTION	WIRE/CONDUIT	BREAKER POLE AMP	AØ	BØ	CØ	CR./POLE CUIT	DESCRIPTION	WIRE/CONDUIT	BREAKER POLE AMP	
1	1 FACP	#10-3/4" C	1 20	1.0			2	2 SPARE		1 20	
3	3 BLOCK HEATER	#10-1" C	1 20		1.0		4	4 SPARE		1 20	
5	5 BATTERY CHARGER	#10-1" C	1 20			0.5	6	6 SPARE		1 20	
7	7 SPARE	-	1 20	-	-	-	8	8 SPARE		1 20	
9	9 SPARE	-	1 20	-	-	-	10	10 SPARE		1 20	
11	11 SPARE	-	1 20	-	-	-	12	12 SPARE		1 20	
-	13 SPACE AND PROVISIONS	-	-	-	-	-	-	14 SPACE AND PROVISIONS	-	-	
-	15 SPACE AND PROVISIONS	-	-	-	-	-	-	16 SPACE AND PROVISIONS	-	-	
-	17 SPACE AND PROVISIONS	-	-	-	-	-	-	18 SPACE AND PROVISIONS	-	-	
CONNECTED LOAD =				2.5	1.0	1.0	0.5	MAIN FUSE 50 AMPS			
DEMAND LOAD =				2.5							
MIN AC RATING =				10,000	AMPS SYMMETRICAL		LOCATION STORAGE				

NOTES:  
(1) PROVIDE FUSIBLE BRANCH CIRCUIT PANELBOARD.  
(2) PROVIDE PANELBOARD WITH INTEGRAL SURGE PROTECTION DEVICE.

**WIRING SCHEDULE: PANEL SP**


120 / 208 VOLTS			3 PHASE 4 WIRE			225 AMP BUS			SURFACE MOUNTED		
CR./POLE CUIT	DESCRIPTION	WIRE/CONDUIT	BREAKER POLE AMP	AØ	BØ	CØ	CR./POLE CUIT	DESCRIPTION	WIRE/CONDUIT	BREAKER POLE AMP	
1	1 SPARE	-	1 20	-	-	-	2	2 TELEPHONE		NOTE (2)	
3	3 SPARE	-	1 20	-	-	-	4	4 PA		NOTE (2)	
5	5 SPARE	-	1 20	-	-	-	6	6 SECURITY		NOTE (2)	
7	7 SPARE	-	1 20	-	-	-	8	8 SECURITY		NOTE (2)	
9	9 FIRE ALARM BOOSTER PANEL	#8-3/4" C	1 20	0.4	0.1	0.4	10	10 SECURITY		NOTE (2)	
11	11 SECURITY CKT 17	NOTE (2)	1 20	-	-	-	12	12 SECURITY		NOTE (2)	
13	13 SECURITY CKT 19	NOTE (2)	1 20	0.4	0.4	0.4	14	14 SECURITY CKT 20		NOTE (2)	
15	15 SECURITY CKT 21	NOTE (2)	1 20	-	-	-	16	16 SECURITY		NOTE (2)	
17	17 SPARE	NOTE (2)	1 20	-	-	-	18	18 SECURITY		NOTE (2)	
19	19 SPARE	NOTE (2)	1 20	-	-	-	20	20 REC - SUMP PUMP	#8-3/4" C	1 20	
21	21 WALL HEATER IN HEALTH	NOTE (2)	1 20	-	-	-	22	22 SPARE		1 20	
23	23 WALL HEATER IN HEALTH	NOTE (2)	1 20	-	-	-	24	24 SPARE		1 20	
25	25 BOILER	#10-3/4" C	1 20	0.5	1.5	-	26	26 WALL HEATER IN HEALTH	NOTE (2)	1 20	
27	27 SHUNT-TRIP SPACE	-	-	-	-	1.5	28	28 WALL HEATER IN HEALTH	NOTE (2)	1 20	
29	29 BOILER	#10-3/4" C	1 20	-	-	0.5	30	30 REC - GENERATOR	#10-3/4" C	1 20	
31	31 SHUNT-TRIP SPACE	-	-	-	-	1.5	32	32 COOLER CONDENSER (ROOF)	#310+	3 35	
33	33 4-POLE CONTACTOR	#10-3/4" C	1 20	-	-	0.1	34	34 (ROOF)	#10G-3/4" C	1 20	
35	35 CHILLER HEAT TRACE (1)	#10-3/4" C	1 20	-	-	1.5	36	36 (ROOF)	-	1 20	
37	37 REC - CHEST FREEZER	#10-3/4" C	1 20	1.0	1.0	-	38	38 FREEZER CONDENSER (ROOF)	#312+	3 20	
39	39 REC - REFRIG (HEALTH) (1)	#8-3/4" C	1 20	0.5	1.0	-	40	40 (ROOF)	#12G-3/4" C	1 20	
41	41 REC - DATA	#8-3/4" C	1 20	-	-	-	42	42 (ROOF)	#12G-3/4" C	1 20	
43	43 REC - DATA	#8-3/4" C	1 20	0.5	1.0	-	44	44 FREEZER EVAPORATOR	#312+	2 15	
45	45 REC - DATA	#8-3/4" C	1 20	-	-	-	46	46 (ROOF)	#12G-3/4" C	1 20	
47	47 REC - CONTROL RM	#8-3/4" C	1 20	-	-	-	48	48 COOLER EVAPORATOR	#12-3/4" C	1 15	
49	49 REC - DATA	#8-3/4" C	1 20	0.5	-	-	50	50 SPARE	-	1 20	
51	51 REC - DATA	#8-3/4" C	1 20	-	-	-	52	52 SPARE	-	1 20	
53	53 REC - DATA	#8-3/4" C	1 20	-	-	-	54	54 SPARE	-	1 20	
CONNECTED LOAD =				30.6	2.9	17.5	3.6	8.3	5.4	4.9	MAIN BREAKER 150 AMPS
DEMAND LOAD =				28.0	10.4	9.9	10.3				
MIN AC RATING =				10,000	AMPS SYMMETRICAL		LOCATION STORAGE				

NOTES:  
(1) PROVIDE GFCI-TYPE CIRCUIT BREAKER.  
(2) INTERCEPT & SPLICE EXISTING BRANCH CIRCUIT AT PANELBOARD ENCLOSURE, PREVIOUSLY PANEL EL, TO BE USED AS A PULL BOX. MATCH EXISTING WIRING AND CONDUIT AND EXTEND WIRING AND CONDUIT FROM PANEL SP TO PANELBOARD ENCLOSURE.  
(3) PROVIDE PANELBOARD WITH INTEGRAL SURGE PROTECTION DEVICE.

**SCHEDULE OF TRANSFORMERS**

TRANSFORMER DESIG	KVA	LOCATION	PRIMARY FEEDER	SECONDARY TAP WIRING & CONDUIT (NOTE A)	GROUNDING ELECTRODE CONDUCTOR	EQUIPMENT SERVED	NOTES
TSP	15	STORAGE	E-25	4 #8 + #8G-1" C	#8	PANEL EP	1
TSP	45	STORAGE	E-26	4 #10 + #8G-1" C	#8	PANEL SP	1

TRANSFORMER GENERAL NOTES:  
A. TRANSFORMER SECONDARY TAP CONDUCTORS RELATED REFLECT PHASE, NEUTRAL IN WYE CONFIGURATION, AND SUPPLY GROUNDING LAMPERS (SBL) IN ACCORDANCE WITH NATIONAL ELECTRICAL CODE (NEC) ARTICLES 450, 240.21, AND 250.30.  
B. TRANSFORMER SHALL HAVE 480-VOLT, 3-PHASE, DELTA PRIMARY AND 120/208-VOLT, 3-PHASE, WYE SECONDARY.  
TRANSFORMER SPECIFIC NOTES:  
1. PROVIDE ON 4" HIGH HOUSEKEEPING PAD.

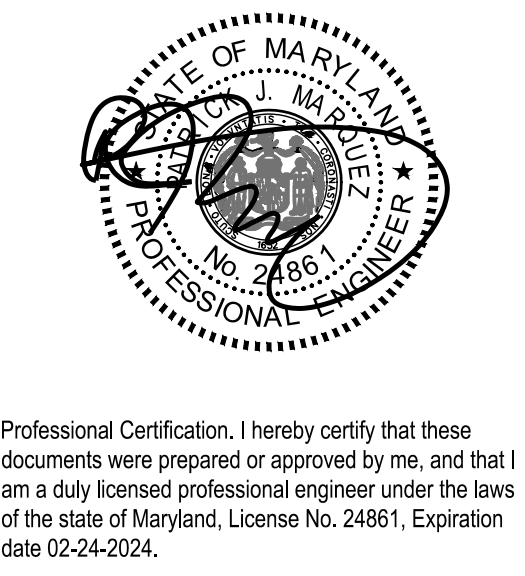

Professional Certification. I hereby certify that these documents were prepared or approved by me, and that I am a duly licensed professional engineer under the laws of the State of Maryland, License No. 24861, Expiration Date 02-24-2024.

**James Posey Associates**  
Engineering Your Vision

Mechanical & Electrical Consulting Engineers  
1155 Red Run Boulevard, Suite 310  
Baltimore, Maryland 21117  
tel 410-265-6100  
jamesposey.com

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	BID SET	02/06/23
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Sheet No	E-7	